



# GYM TO CAFETERIA CONVERSION

300 OIL MILL DR.  
TORNILLO, TEXAS 79853

PROJECT NUMBER: 2022-16



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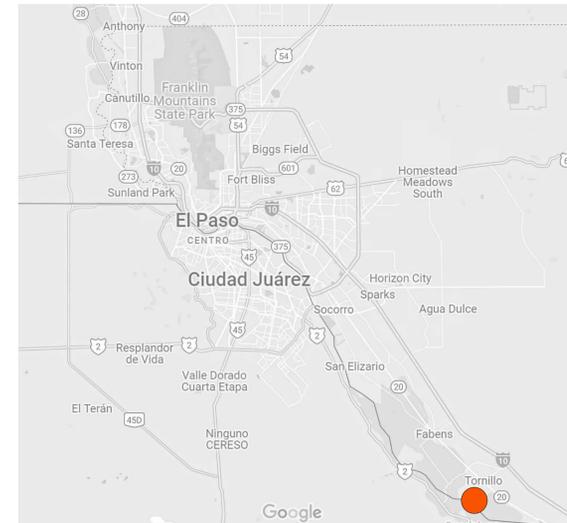
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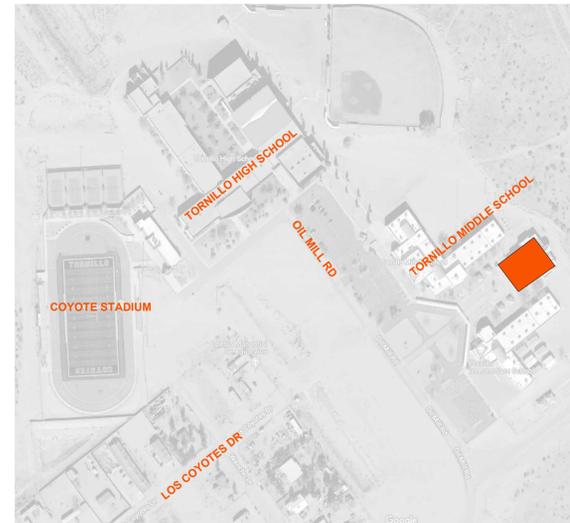
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- P-400 PLUMBING ISOMETRIC VIEWS

### SITE LOCATION:



### VICINITY MAP:



### SCOPE OF WORK:

RENOVATION OF THE ANCILLARY SPACES OF AN EXISTING GYM INTO A COMMERCIAL KITCHEN TO ASSIST THE TORNILLO INDEPENDENT SCHOOL DISTRICT WITH THE CONVERSION OF THIS BUILDING INTO A CAFETERIA. THE AREA BEING RENOVATED IS APPROXIMATELY 4,608 SF.

### MATRIX OF RESPONSIBILITIES:

DESCRIPTION	RESPONSIBILITY
DATA CABLING CONDUITS & ROUTES	GENERAL CONTRACTOR
DATA CABLING & TERMINATIONS	GENERAL CONTRACTOR
FURNITURE	OWNER PROVIDED   OWNER INSTALLED
KITCHEN EQUIPMENT	REFER TO KITCHEN SCHEDULE
SECURITY   SURVEILLANCE SYSTEMS	OWNER PROVIDED   OWNER INSTALLED
SIGNAGE	GC PROVIDED   GC INSTALLED

### DESIGN TEAM:

**ARCHITECT:**  
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COUNTRYMAN & CO.  
Architecture

108 SOUTH STANTON . THIRD FLOOR . EL PASO, TEXAS 79901 915.929.1827

DRAWN BY: PJ | AL  
PROJECT NO: 2022-16  
ISSUED: NOVEMBER 1, 2022

#### REVISION SCHEDULE:

NO.	DATE	DESCRIPTION

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**TORNILLO INDEPENDENT SCHOOL DISTRICT**  
**GYM TO CAFETERIA CONVERSION**  
300 OIL MILL DR. | TORNILLO, TX 79853  
SHEET TITLE:  
**COVER SHEET**

CONSTRUCTION DOCUMENTS

**G000**



ABBREVIATIONS

A LABEL	CLASS A DOOR	ECU	EVAPORATIVE COOLING UNIT	MAINT	MAINTENANCE	SIM	SIMILAR
A/C	AIR CONDITIONER	EF	EXTERIOR FINISH	MATL	MATERIAL	SKLT	SKYLIGHT
A/E	ARCHITECT / ENGINEER	EFS	EXTERIOR FINISH SYSTEM	MAX	MAXIMUM	SLD WDW	SLIDING WINDOW
AAP	ALARM ANNUNCIATOR PANEL	EGB	EXTERIOR GYPSUM BOARD	MBR	MASTER BEDROOM	SND	SANITARY NAPKIN DISPENSER
ABC	ACCESS GATE BASE COURSE	EGSB	EXTERIOR GYPSUM SHEATHING BOARD	MC	MEDICINE CABINET	SP	STAIRS
AC	ASBESTOS CEMENT,	EH	ELECTRIC HEATER	MECH	MECHANICAL	SPEC	SPECIFICATIONS
ASPHALTIC	CONCRETE	EHD	ELECTRIC HAND DRYER	MED	MEDICAL	SPKLR	SPEAKER
ACC	ACCESSIBLE	EIFS	EXTERIOR INSULATION AND FINISH SYSTEM	MEMB	MEMBRANE	SPKR	SPEAKER
ACP	ASPHALTIC CONCRETE	EL	ELEVATOR	MEZZ	MEZZANINE	SQ	SQUARE
PAVING	ACUSTICAL	ELCT	ELECTRIC	MFR	MANUFACTURER	SS	SERVICE SINK
ACST	ACUSTICAL CEILING TILE	ELV	ELEVATION	STA	STAIR	STA	STATION
ACT	ACUSTICAL CEILING TILE	EMER	EMERGENCY	STC	SOUND TRANSMISSION CLASS	STD	STANDARD
AD	AREA DRAIN	ENCL	ENCLOSURE	STD	STANDARD	STO	STORAGE
ADDL	ADDITIONAL	EMS	ENERGY MANAGEMENT SYSTEM	STR	STRUCTURE	STRUC	STRUCTURAL
ADDM	ADDENDUM	ENGL	ENGINEER	SUHV	SUSPENDED UNIT HEATER	SV	SHEET VINYL
ADH	ADHESIVE	ENTR	ENTRANCE	MO	MASONRY OPENING	SWBD	SWITCH BOARD
ADJ	ADJACENT	EPS	EXPANDED POLYSTYRENE BOARD (INSULATION)	MRB	MARBLE BASE	SYM	SYMBOL
AFF	ABOVE FINISH FLOOR	EQ	EQUAL	MS	MOUNTED	SYS	SYSTEM
AFS	ABOVE FINISH GRADE	EQUIP	EQUIPMENT	MT	METAL		
AGGR	AGGREGATE	ERD	EXISTING ROOF DRAIN	NRC	NOISE REDUCTION COEFFICIENT		
AHU	AIR HANDLING UNIT	EST	ESTIMATED	MULL	MULLION	T	TREAD
ALT	ALTERNATE	EVAP	EVAPORATIVE	MVBL	MOVABLE	T&G	TONGUE AND GROOVE
ALUM	ALUMINUM	EWC	ELECTRIC WATER COOLER	N	NORTH	T/S	TUB / SHOWER
ANOD	ANODIZE	EWI	ELECTRIC WATER HEATER	NA	NOT APPLICABLE	TB	TOWEL BAR
ANT	ANTENNA	EWS	EYE WASH STATION	NAT	NATURAL	TC	TERRACOTA
AP	ACCESS PANEL	EXC	EXCAVATE	NIC	NOT IN CONTRACT	TCA	TELEPHONE CONTROL PANEL
APPROX	APPROXIMATE	EXIST	EXISTING	NO	NUMBER	TD	TOWEL DISPENSER, TRENCH DRAIN
ARCH	ARCHITECT	EXP	EXPOSED	NOM	NOMINAL	TEL	TELEPHONE
ASC	ABOVE SUSPENDED CEILING	EXT	EXTERIOR	NR	NOISE REDUCTION	TEMP	TEMPERATURE
ASPH	ASPHALT	NRC	NOISE REDUCTION COEFFICIENT	NTS	NOT TO SCALE	TFA	TO FLOOR ABOVE
ASSY	ASSEMBLY	FA	FIRE ALARM	OA	OVERALL	TFB	TO FLOOR BELOW
ATM	AUTOMATIC TELLER MACHINE	FAAP	FIRE ALARM ANNUNCIATOR PANEL	OD	ON CENTER	THD	THREAD
AUTO	AUTOMATIC	FACP	FIRE ALARM CONTROL PANEL	OC	OUTSIDE DIAMETER	THK	THICKNESS
AV	AUDIO VISUAL	FAS	FASCIA	OD	OWNER FURNISHED	THRES	THRESHOLD
AVE	AVENUE	FB	FIRE BLANKET	OF	OVERFLOW DRAIN	THRU	THROUGH
B LABEL	CLASS B DOOR	FD	FLOOR DRAIN	OFD	OFFICE	TK BD	TACK BOARD
BALC	BALCONY	FDC	FIRE DEPARTMENT CONNECTION	OFF	OFFICE	TMPD GL	TEMPERED GLASS
BB	BULLETIN BOARD	FE	FIRE EXTINGUISHER	OH	OPPOSITE HAND	TN	TRUE NORTH
BD	BOARD	FEC	FIRE EXTINGUISHER CABINET	OP	OPENING	TOB	TOP OF BEAM
BDRY	BOUNDARY	FF	FINISH FLOOR	OPP	OPPOSITE	TOC	TOP OF CURB
BEV	BEVEL	FFE	FINISH FLOOR ELEVATION	OSB	ORIENTED STRAND BOARD	TOF	TOP OF FOOTING
BITU	BITUMINOUS	FH	FIRE HYDRANT	PA	PUBLIC ADDRESS	TOJ	TOP OF JOIST
BJT	BED JOINT	FHC	FIRE HOSE CABINET	PAR	PARALLEL	TOM	TOP OF MASONRY
BLDG	BUILDING	FIN	FINISH	PB	PULL BOX	TOP	TOP OF PARAPET
BLVD	BOULEVARD	FIXT	FIXTURE	PBD	PARTICLE BOARD	TOPG	TOPOGRAPHY
BLW	BELOW	FLSH	FLASHING	PCB	POUNDS PER CUBIC FOOT	TOW	TOP OF WALL
BM	BENCH MARK	FLR	FLOOR	PCF	POUNDS PER CUBIC FOOT	TPD	TOILET PAPER DISPENSER
BOT	BOTTOM	FLUOR	FLUORESCENT	PED	PEDESTAL	TPH	TOILET PAPER HOLDER
BR	BEDROOM	FP	FIREPROOFING	PERF	PERFORATED	TR	TOWEL RACK
BRG	BEARING	FR	FIRE RESISTANT	PERFAB	PREFABRICATED	TRANS	TRANSOM
BRZ	BRIDGE	FAS	FASTENER	PER	PERMETER	TS	TUB STEEL
BTWN	BETWEEN	FT	FOOT	PF	PORTABLE FIRE EXTINGUISHER	TOW	TOWEL SHELF
BUR	BUILT-UP ROOFING	FTG	FOOTING	PG	PRESSURE GAUGE	TSTAT	THERMOSTAT
C	CELSIUS	FURN	FURNACE	PLAM	PLASTIC LAMINATE	TV	TELEVISION
C LABEL	CLASS C DOOR	FUT	FUTURE	PLYWD	PLYWOOD	TYP	TYPICAL
CAB	CABINET	G	NATURAL GAS	PML	PANEL	UC	UNDERCUT
CAD	COMPUTER AIDED DRAFTING	GA	GAUGE	PR	PIPE RAIL	UGND	UNDERGROUND
CAT	CATALOG	GALV	GALVANIZED	PREFIN	PREFINISHED	UH	UNIT HEATER
CATV	COMMUNITY ANTENNA TELEVISION	GB	GRAB BAR	PRKG	PARKING	UL	UNDERWRITERS LABORATORIES
CCTV	TELEVISION	GC	GENERAL CONTRACTOR	PSF	POUNDS PER SQUARE FOOT	UNFIN	UNFINISHED
CEM	CLOSE CIRCUIT TELEVISION	GG	GROUT CLEAN OUT	PSI	POUNDS PER SQUARE INCH	UNIV	UNIVERSAL
CF	CONTRACTOR FURNISHED	GL	GLASS	PT	PAPER TOWEL DISPENSER	UNO	UNLESS NOTED OTHERWISE
CFE	CONTRACTOR FURNISHED EQUIPMENT	GLU LAM	GLUED LAMINATED WOOD	PTD	PARTITION	UTIL	UTILITY
CFLG	COUNTERFLASHING	GLZ	GLAZING	PTR	PAPER TOWEL RECEPTACLE	VAC	VACUUM
CH BD	CHALK BOARD	GT	GREASE TRAP	PVG	PAVING	VAN	VANITY
CI	CAST IRON	GYM	GYMNASIUM	QT	QUARRY TILE	VAP PRF	VAPOR PROOF
CIR	CIRCLE	GYP	GYPSUM	QTB	QUARRY TILE BASE	VAR	VARIABLES
CIRC	CIRCUMFERENCE	HAZ	HAZARD	QTF	QUARRY TILE FLOOR	VB	VINYLBASE
CK	CAULK	HB	HOSE BIB	QTY	QUANTITY	VCT	VINYL COMPOSITION TILE
CLG	CENTER LINE	HC	HANDCAP, HOLLOW CORE	R	RADIUS	VEH	VEHICLE
CLM	CEILING	HD	HAND DRYER, HEAD	RB	RESILIENT BASE	VENT	VENTILATION
CLO	CLOSET	HDBD	HARD BOARD	RH	ROBE HOOK	VEST	VESTIBULE
CLRM	CLASSROOM	HDR	HEADER	RCP	REFLECTED CEILING PLAN	VID	VIDEO
CM	CENTIMETERS	HDW	HARDWARE	RCTP	RECEPTION	VNR	VENEER
CMU	CONCRETE MASONRY UNIT	HM	HOLLOW METAL	RD	ROOF DRAIN	VOL	VOLUME
COL	COLUMN	HORIZ	HORIZONTAL	REB	REINFORCING STEEL BARS	VOLT	VOLTAGE
COMB	COMBINATION	HS	HAND SINK	REFR	REFRIGERATOR	VR	VAPOR RETARDER
COMM	COMMUNICATION	HT	HEIGHT	REFL	REFLECTED	VRFY	VERIFY
COMP	COMPONENT	HVAC	HEATING, VENTILATING, AND AIR CONDITIONING	REFR	REFRIGERATOR	VTR	VENT THROUGH ROOF
COMPT	COMPARTMENT	IO	INPUT / OUTPUT	REG	REGISTER	VWC	VINYL WALL COVERING
CONC	CONCRETE	ID	INSIDE DIAMETER	REIN	REINFORCED	W	WEST
CONSTR	CONSTRUCTION	IDENT	IDENTIFICATION	REMO	REMOVABLE	W/	WITH
CONT	CONTINUOUS	IIC	IMPACT INSULATION CLASS (INCHES)	REQD	REQUIRED	W/O	WITHOUT
CONTR	CONTRACTOR	IN	INCHES	RESIL	RESILIENT	W/W	WALL TO WALL
CORR	CORRIDOR	INCL	INCLUDE	REST	RESTROOM	WB	WOOD BASE
CPT	CARPET	INCLD	INCLUDE	REV	REVISION	WBL	WOOD BLOCKING
CR	CONTROL ROOM	INFO	INFORMATION	RFG	ROOFING	WCL	WATER CLOSET
CT	CERAMIC TILE	INSUL	INSULATION	RH	RIGHT HAND	WCL	WALL CLEAN OUT
CTB	CERAMIC TILE BASE	INT	INTERIOR	RHR	RIGHT HAND REVERSE	WD	WOOD
CTR	CENTER	INTRCOM	INTERCOMMUNICATIONS	RL	ROOF LEADER	WDW	WINDOW
CU	CUBIC	INV	INVERT	RO	ROUGH OPENING	WFAB	WALL FABRIC
D	DRAIN	JAN	JANITOR	ROW	RIGHT OF WAY	WCL	WIRED GLASS
D LABEL	CLASS D DOOR	JBOX	JUNCTION BOX	RT	RIGHT	WH	WATER HEATER
dB	DECIBEL	K	KILO, THOUSAND	RTU	ROOF TOP UNIT	WHSE	WAREHOUSE
DBL	DOUBLE	KIT	KITCHEN	RV	ROOF VENT	WLD	WELDED
DEG	DEGREE	KO	KNOCK OUT	S	SOUTH	WM	WATER METER
DEMO	DEMOLITION	KPL	KICK PLATE	SB	SPLASH BLOCK	WP	WATER PROOFING
DEPT	DEPARTMENT	L	LITER	SC	SOLID CORE	WSCT	WAINSCOT
DF	DRINKING FOUNTAIN	LADR	LABORATORY	SCD	SCHEDULE	WSL	WEATHER SEAL
DIA	DIAMETER	LAD	LADDER	SCHD	SCHEDULE	WT	WEIGHT
DIAG	DIAGONAL	LAM	LAMINATED	SCP	SCUPPER	WU	WINDOW UNIT
DIM	DIMENSION	LEDR	LEADER	SCR	SHOWER CURTAIN ROD	WWF	WELDED WIRE FABRIC
DISP	DISPENSER	LDR	LEADER	SCRN	SCREEN	WWM	WELDED WIRE MESH
DIV	DIVISION	LH	LEFT HAND	SCWD	SOLID CORE WOOD DOOR	X BRACE	CROSS
DL	DEAD LOAD	LHR	LEFT HAND REVERSE	SD	SMOKE DETECTOR	XL	EXTRA LARGE
DMPF	DAMP PROOFING	LIB	LIBRARY	SECT	SECTION	XPS	EXTRUDED POLYSTYRENE BOARD
DN	DOWN	LIF	LIVE LOAD	SF	SQUARE FOOT	YCO	YARD CLEANOUT
DR	DOOR	LNG	LIQUID NATURAL GAS	SH	SINGLE HUNG	YD	YARD
DS	DOWNSPOUT	LPT	LOW POINT	SHFT	SHIFT	YH	YARD HYDRANT
DTL	DETAIL	LVR	LOUVER	SHLVS	SHELVES	YR	YEAR
DW	DISHWASHER	LWC	LIGHT WEIGHT CONCRETE	SHT	SHEET		
DWG(S)	DRAWING(S)	M	METER	SHTG	SHEATHING		
E LABEL	CLASS E DOOR	MACH	MACHINE				
EA	EACH						


GENERAL NOTES

- PRE-CONSTRUCTION**
- CONTRACTOR SHALL SCHEDULE AND CONDUCT A PRE-DEMOLITION MEETING WITH THE OWNER AND THE ARCHITECT PRIOR TO PROCEEDING WITH DEMOLITION IN EACH AREA.
  - CONTRACTOR SHALL BE PREPARED FOR AND PARTICIPATE IN WEEKLY OWNER / ARCHITECT / CONTRACTOR MEETING IF REQUESTED.
  - CONTRACTOR SHALL RECORD MEETING MINUTES AND DISTRIBUTE TO ALL ATTENDEES WITHIN THREE WORKING DAYS. TOPICS TO INCLUDE, BUT NOT LIMITED TO SCHEDULE, PHASING, VERIFICATION OF EXISTING UTILITIES AND POWER OUTAGES.
  - IT IS HIGHLY RECOMMENDED THAT THE CONTRACTOR VISITS THE SITE PRIOR TO BID TO FAMILIARIZE THEMSELVES TO ALL EXISTING CONDITIONS.
  - ALL QUESTIONS AND CLARIFICATIONS SHALL BE SUBMITTED TO THE ARCHITECT PRIOR TO SUBMITTAL OF BIDS.


- DRAWINGS**
- VERIFY ALL DIMENSIONS BEFORE PROCEEDING WITH WORK, ANY CONFLICT AND / OR DISCREPANCIES SHALL BE BROUGHT TO THE ATTENTION OF THE ARCHITECT.
  - WHERE DIMENSIONAL OR DETAIL DISCREPANCIES EXIST BETWEEN THE PLANS AND SECTIONS AND DETAILS, THESE DISCREPANCIES SHALL BE BROUGHT TO THE ATTENTION OF THE ARCHITECT BEFORE PROCEEDING WITH WORK.
  - ALL ELECTRICAL AND MECHANICAL FIXTURES EXPOSED TO VIEW SHALL BE LOCATED AS INDICATED ON THE ARCHITECTURAL DRAWINGS. IN CASE OF CONFLICT, VERIFY WITH THE ARCHITECT BEFORE PROCEEDING WITH WORK.
  - FOR INTERIOR WALL ASSEMBLIES REFER TO PARTITION TYPES ON DRAWINGS.
  - FOR ASSEMBLY LOCATION REFER TO FLOOR PLANS, FOR CEILING ASSEMBLIES REFER TO RCP DETAILS. REFER TO REFLECTED CEILING PLAN FOR ASSEMBLY LOCATIONS.
  - WHERE REQUIRED, FURR-OUT PARTITIONS TO ACCOMMODATE PIPING AND CONDUITS LARGER OR DEEPER THAN THE PARTITIONS THICKNESS INDICATED, FURRING AROUND PIPE / CONDUIT OR FURRING OUT OF ENTIRE PARTITION TO BE DETERMINED BY THE ARCHITECT TO BE ACCEPTABLE.
  - ALL GYPSUM BOARD WALL SHALL BE 5/8" F.C. OR TYPE "X" FIRE RATED.

- PROJECT SIGN**
- PROJECT SIGN SHALL BE PROVIDED AND INSTALLED PRIOR TO BEGINNING WORK.
  - RENOVATIONS AND TENANT IMPROVEMENTS: 24"x36" WINDOW DECAL PLACED IN HIGHLY VISIBLBLE LOCATION.
  - NEW CONSTRUCTION: 4'x8' PLYWOOD CONSTRUCTION SIGN WITH GRAPHICS ADHERED TO THE FRONT, 4'x8" IN SIZE, MOUNTED ON POSTS, WITH A HEIGHT TO TOP OF SIGN OF 10'.
  - PROJECT SIGN GRAPHICS SHALL BE AS ILLUSTRATED BELOW.

SYMBOLS

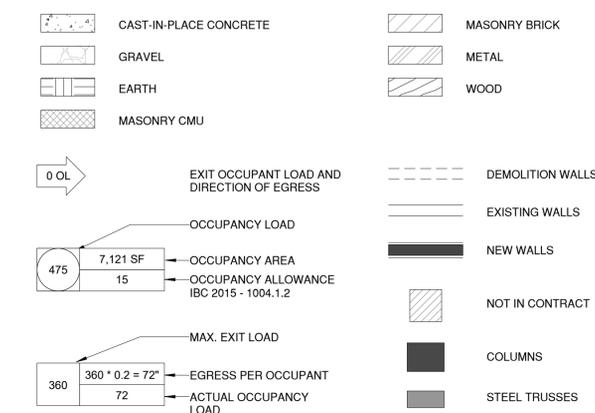


RENOVATION

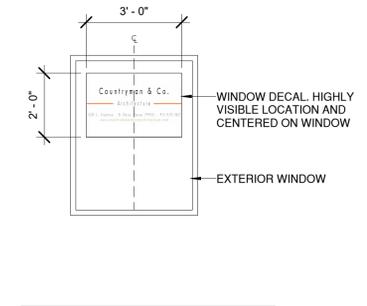


PROJECT SIGN - WINDOW DECAL

NEW CONSTRUCTION

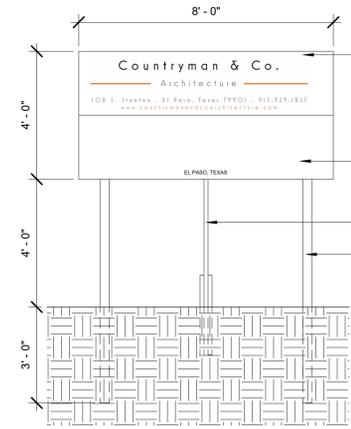

PROJECT SIGN - ELEVATION

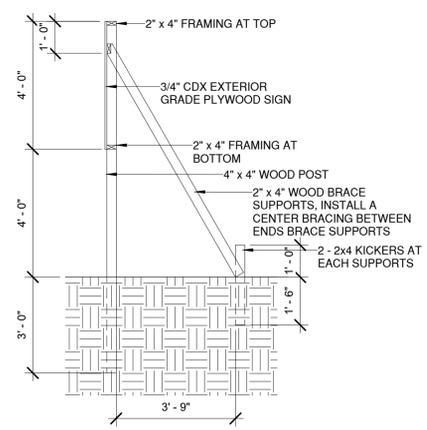

PROJECT SIGN - BRACING

- NOTE:
- CHECK FOR UNDERGROUND UTILITIES AND IRRIGATION SYSTEM PRIOR TO DIGGING POST HOLES
  - ALL LUMBER SHALL BE PRESSURE TREATED (PAINTED) LANE, TOWARDS INCOMING TRAFFIC, CENTERED WITHIN 10 FT OF THE FRONT BOUNDARY LINE



108 SOUTH STANTON, THIRD FLOOR, EL PASO, TEXAS 79901 915.929.1827



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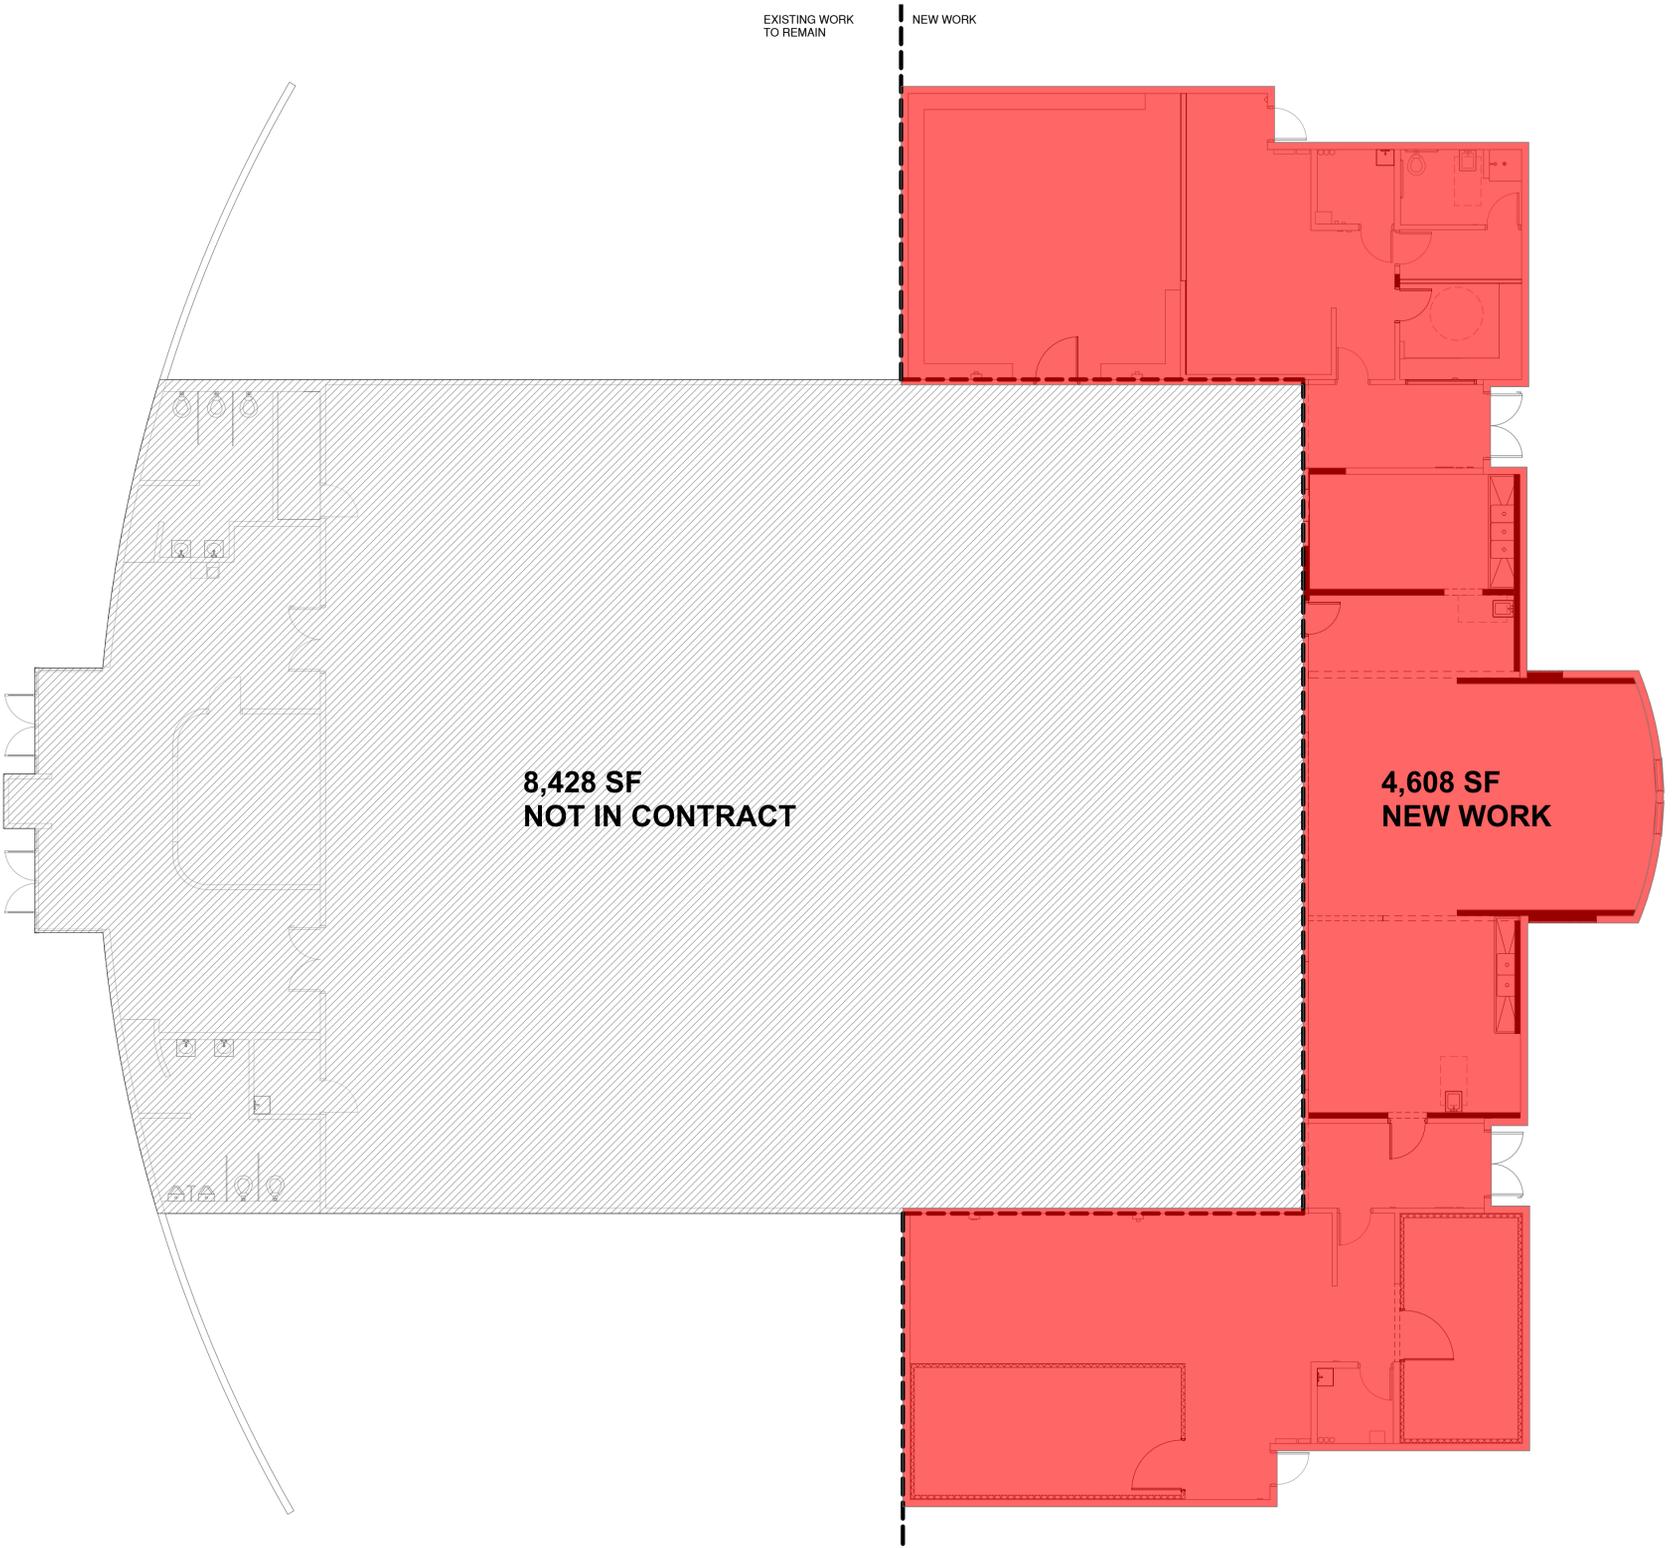


CONSTRUCTION DOCUMENTS

G001







01 REFERENCE FLOOR PLAN  
1/8" = 1'-0"



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Architecture

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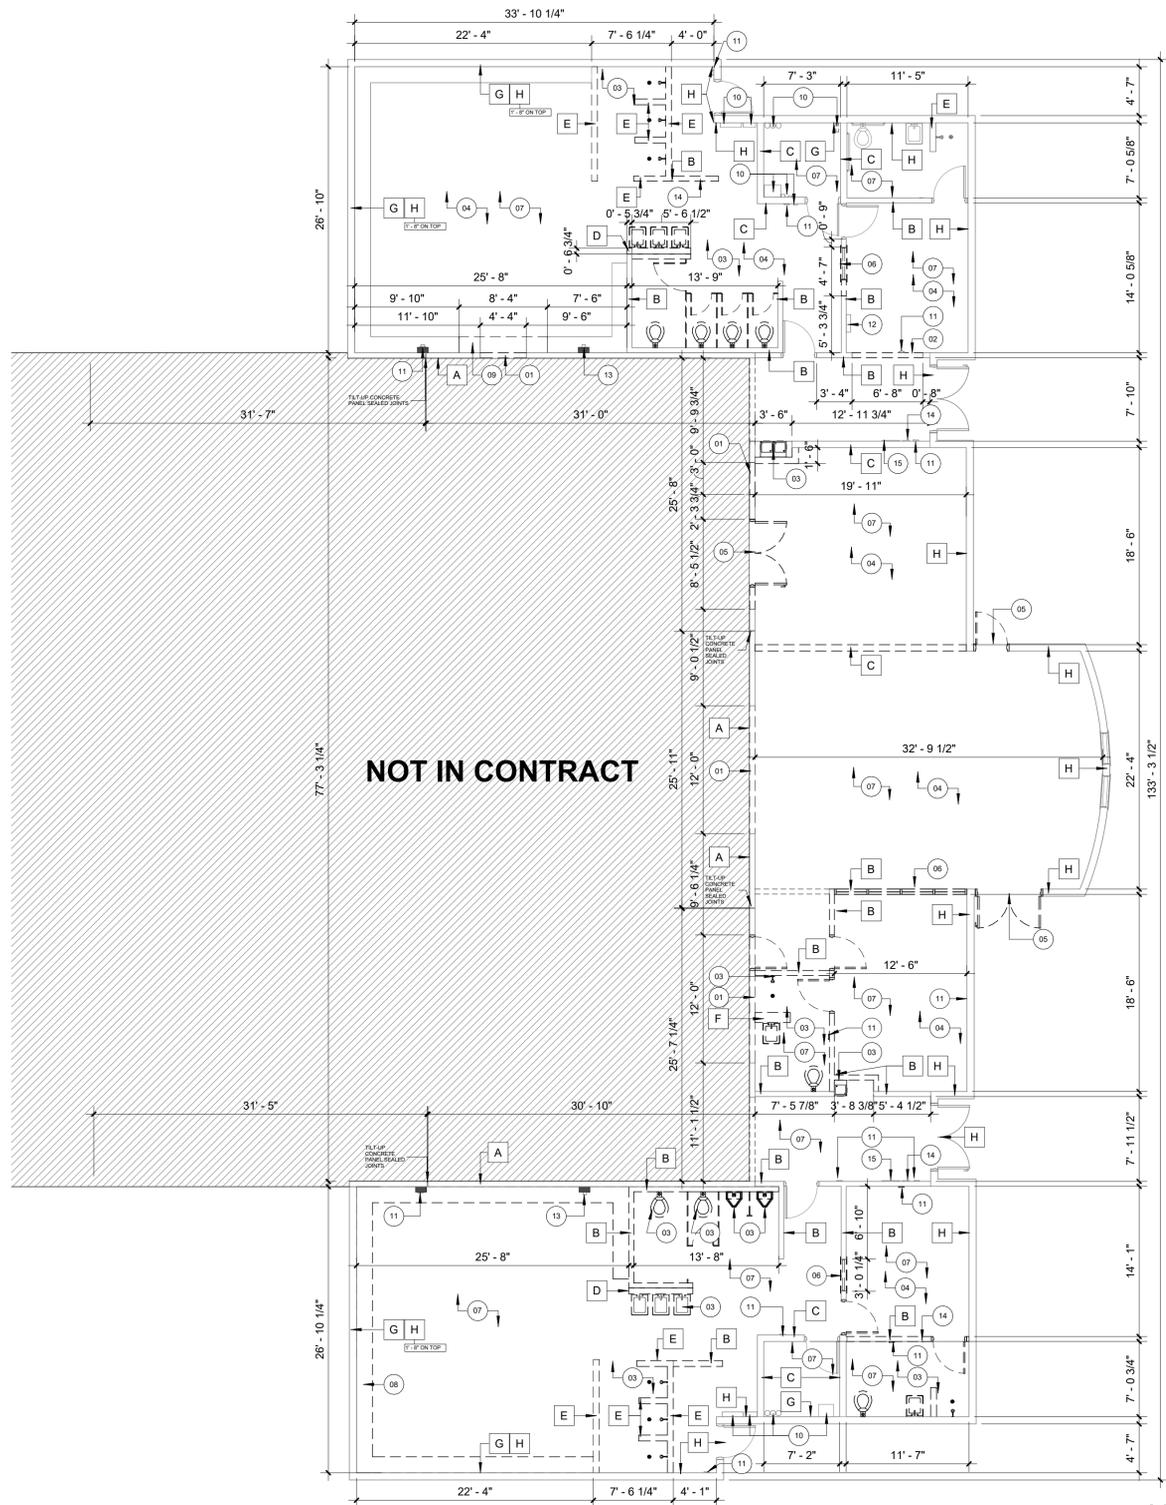
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CONSTRUCTION DOCUMENTS

AR100

SHEET TITLE:  
REFERENCE FLOOR PLAN



01 DEMOLITION FLOOR PLAN  
1/8" = 1'-0"

PRESUMED WALL TYPES

<p><b>A EXTERIOR   INTERIOR WALL</b></p> <p>6" TILT-UP WALL (CONCRETE PANEL JOINTS ARE SHOWN IN FLOOR PLAN)</p>	<p><b>B INTERIOR PARTITION WALL</b></p> <p>6"x8"x8" PAINTED CMU</p>	<p><b>C INTERIOR PARTITION</b></p> <p>6"x8"x8" PAINTED CMU WITH 1 9/16" THICK OF 8"x16" GROUND FACE CAP BLOCK</p>	<p><b>D INTERIOR PARTITION</b></p> <p>7" METAL STUD FURR-OUT WALL ATTACHED TO A 6x8x8 CMU WALL</p>	<p><b>E INTERIOR PARTITION</b></p> <p>6"x8"x8" CMU WITH 1" TILE ATTACHED. LOCATED JUST IN SHOWERS.</p>	<p><b>F INTERIOR PARTITION</b></p> <p>6"x8"x8" TWO ROWS OF CMU AND 1" TILE ATTACHED. LOCATED JUST IN SHOWERS.</p>
<p><b>G EXTERIOR WALL</b></p> <p>6"x8"x16" CMU WITH EIFS SYSTEM</p>	<p><b>H EXTERIOR WALL</b></p> <p>6"x8"x8" CMU WITH EIFS SYSTEM</p>				

DEMOLITION NOTES	
NO.	ITEM DESCRIPTION
01	DEMOLISH AS NEEDED TO ACHIEVE NEW OPENINGS FOR NEW DOORS PLACEMENT. REFER TO DOOR SCHEDULE AND STRUCTURAL DRAWINGS
02	DEMOLISH AS NEEDED TO ACHIEVE NEW OPENINGS FOR NEW WINDOWS PLACEMENT. REFER TO DOOR SCHEDULE AND STRUCTURAL DRAWINGS
03	REMOVE EXISTING PLUMBING FIXTURES. REFER TO PLUMBING DRAWINGS.
04	ALL FURNITURE IS TO BE REMOVED PRIOR TO CONSTRUCTION COMMENCEMENT AND RETURNED TO OWNER, OR DISPOSED OF, AT THEIR DIRECTION.
05	REMOVE EXISTING DOOR AND FRAME. PREPARE FOR NEW WORK AND REFER TO NEW DRAWINGS FOR INFILL OR OPENING SPECIFICATIONS.
06	REMOVE EXISTING WINDOW AND FRAME. PREPARE FOR NEW WORK AND REFER TO NEW DRAWINGS FOR INFILL OR OPENING SPECIFICATIONS.
07	REMOVE EXISTING FLOOR FINISHES AND VINYL WALL BASE. PREPARE FOR NEW WORK AND REFER TO FINISH SCHEDULES.
08	DEMOLISH CONCRETE PLATFORM AND PREPARE FOR NEW FINISH FLOOR. REFER TO FINISH SCHEDULE.
09	CAREFULLY CUT PORTION OF CONCRETE PLATFORM FOR NEW ENTRANCE. PREPARE FOR NEW FINISH FLOOR. REFER TO FINISH SCHEDULE.
10	MEP INFRASTRUCTURE TO REMAIN. REFER TO MEP DRAWINGS FOR MORE INFORMATION.
11	FIRE ALARM DEVICES TO BE RELOCATED AS NEEDED THROUGHOUT PROJECT. REFER TO ELECTRICAL DRAWINGS.
12	ELECTRONIC SECURITY PANEL TO REMAIN.
13	ELECTRICAL EQUIPMENT. REFER TO MEP DRAWINGS
14	THERMOSTAT. REFER TO MEP DRAWINGS.
15	FIRE EXTINGUISHER CABINET TO REMAIN.

CAUTION : LOAD-BEARING, STRUCTURAL ELEMENTS ARE SHOWN TO BE DEMOLISHED. REFER TO THE STRUCTURAL DRAWINGS. COMPLY WITH THE STRUCTURAL ENGINEER'S DIRECTIVES.



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Architecture

108 SOUTH STANTON, THIRD FLOOR, EL PASO, TEXAS 79901 915.929.1827



DRAWN BY: PJ | AL  
PROJECT NO: 2022-16  
ISSUED: NOVEMBER 1, 2022

REVISION SCHEDULE:

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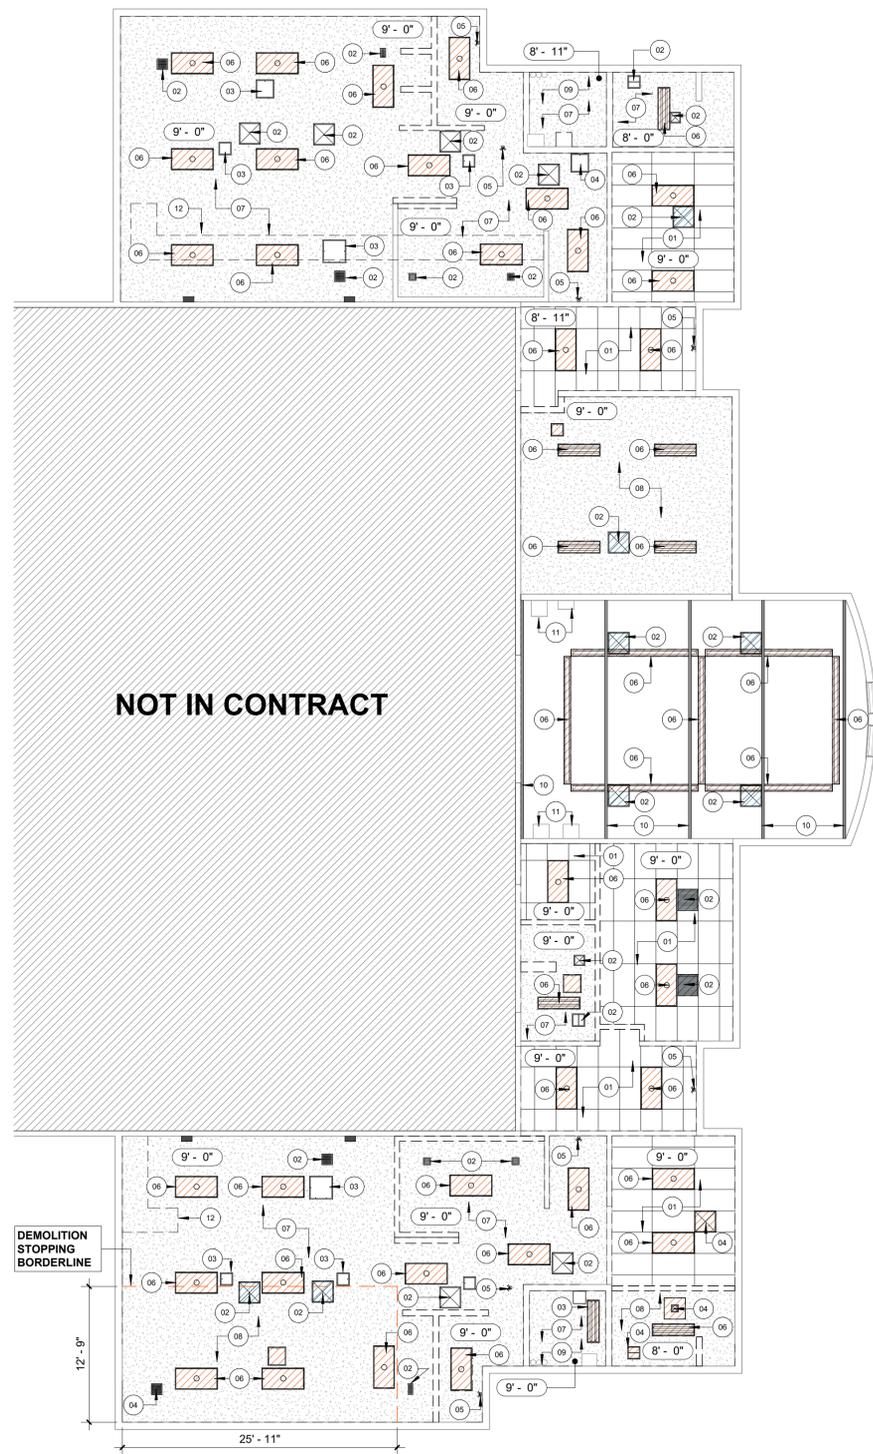
TORNILLO INDEPENDENT SCHOOL DISTRICT  
GYM TO CAFETERIA CONVERSION  
300 OIL MILL DR. | TORNILLO, TX 79853

CONSTRUCTION DOCUMENTS

AD100

SHEET TITLE:  
DEMOLITION FLOOR PLAN & PRESUMED WALL TYPES

11/15/2022 10:15:00 AM Jennifer Countryman - Construction Documents - Tornillo Independent School District - Gym to Cafeteria Conversion - 2022-16 - 11/15/2022 10:15:00 AM



01 DEMOLITION REFLECTED CEILING PLAN  
1/8" = 1'-0"

DEMOLITION NOTES	
NO.	ITEM DESCRIPTION
01	REMOVE ALL EXISTING LAY-IN CEILING, AND ACOUSTICAL GRID. COORDINATE WITH NEW WORK. REFER TO MECHANICAL AND ELECTRICAL DRAWINGS.
02	MECHANICAL SUPPLIES AND MISCELLANEOUS ITEMS TO REMAIN AND TO BE ADJUSTED IF NECESSARY TO ALIGN WITH NEW LAY-IN CEILING. REFER TO MECHANICAL DRAWINGS.
03	CEILING ACCESS DOOR TO REMAIN ON EXISTING GYP. BOARD TO REMAIN.
04	REMOVE ALL MECHANICAL AND MISCELLANEOUS ITEMS AT COOLER   FREEZER LOCATIONS. COORDINATE WITH NEW DRAWINGS.
05	REMOVE ALL CEILING MOUNTED EXIT SIGNS AND EMERGENCY LIGHTS. COORDINATE WITH NEW WORK. REFER TO ELECTRICAL DRAWINGS
06	CAREFULLY REMOVE ALL LIGHT FIXTURES AND MISCELLANEOUS ITEMS, AND PREPARE FOR NEW WORK. PATCH AND REPAIR AS NEEDED ON EXISTING GYP. TO REMAIN. REFER TO ELECTRICAL DRAWINGS.
07	EXISTING GYP. BOARD AND SUPPORT TO REMAIN. PATCH, PAINT AND REPAIR IF NECESSARY. MATCH EXISTING CEILING TEXTURE.
08	REMOVE GYP. BOARD CEILING, COORDINATE WITH NEW WORK. REFER TO MECHANICAL AND ELECTRICAL DRAWINGS.
09	MEP INFRASTRUCTURE TO REMAIN. REFER TO MEP DRAWINGS FOR MORE INFORMATION.
10	STEEL TRUSSES TO REMAIN.
11	VERTICAL DUCTWORK TO REMAIN.
12	CAREFULLY SAW CUT GYP. BOARD CEILING TO INSTALL NEW RETURN DUCTWORK. REFER TO MECHANICAL DRAWINGS. PATCH, PAINT AND REPAIR AS NEED TO MATCH EXISTING CEILING TEXTURE.

LEGEND	
	TO BE ADJUSTED
	TO BE REMOVED
	TO REMAIN



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108 SOUTH STANTON | THIRD FLOOR | EL PASO, TEXAS 79901 | 915.929.1827



DRAWN BY: AL  
PROJECT NO: 2022-16  
ISSUED: NOVEMBER 1, 2022

REVISION SCHEDULE:

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# TORNILLO INDEPENDENT SCHOOL DISTRICT GYM TO CAFETERIA CONVERSION

300 OIL MILL DR. | TORNILLO, TX 79853


SHEET TITLE:

## DEMOLITION REFLECTED CEILING PLAN

CONSTRUCTION DOCUMENTS

AD120

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### WINDOW SCHEDULE

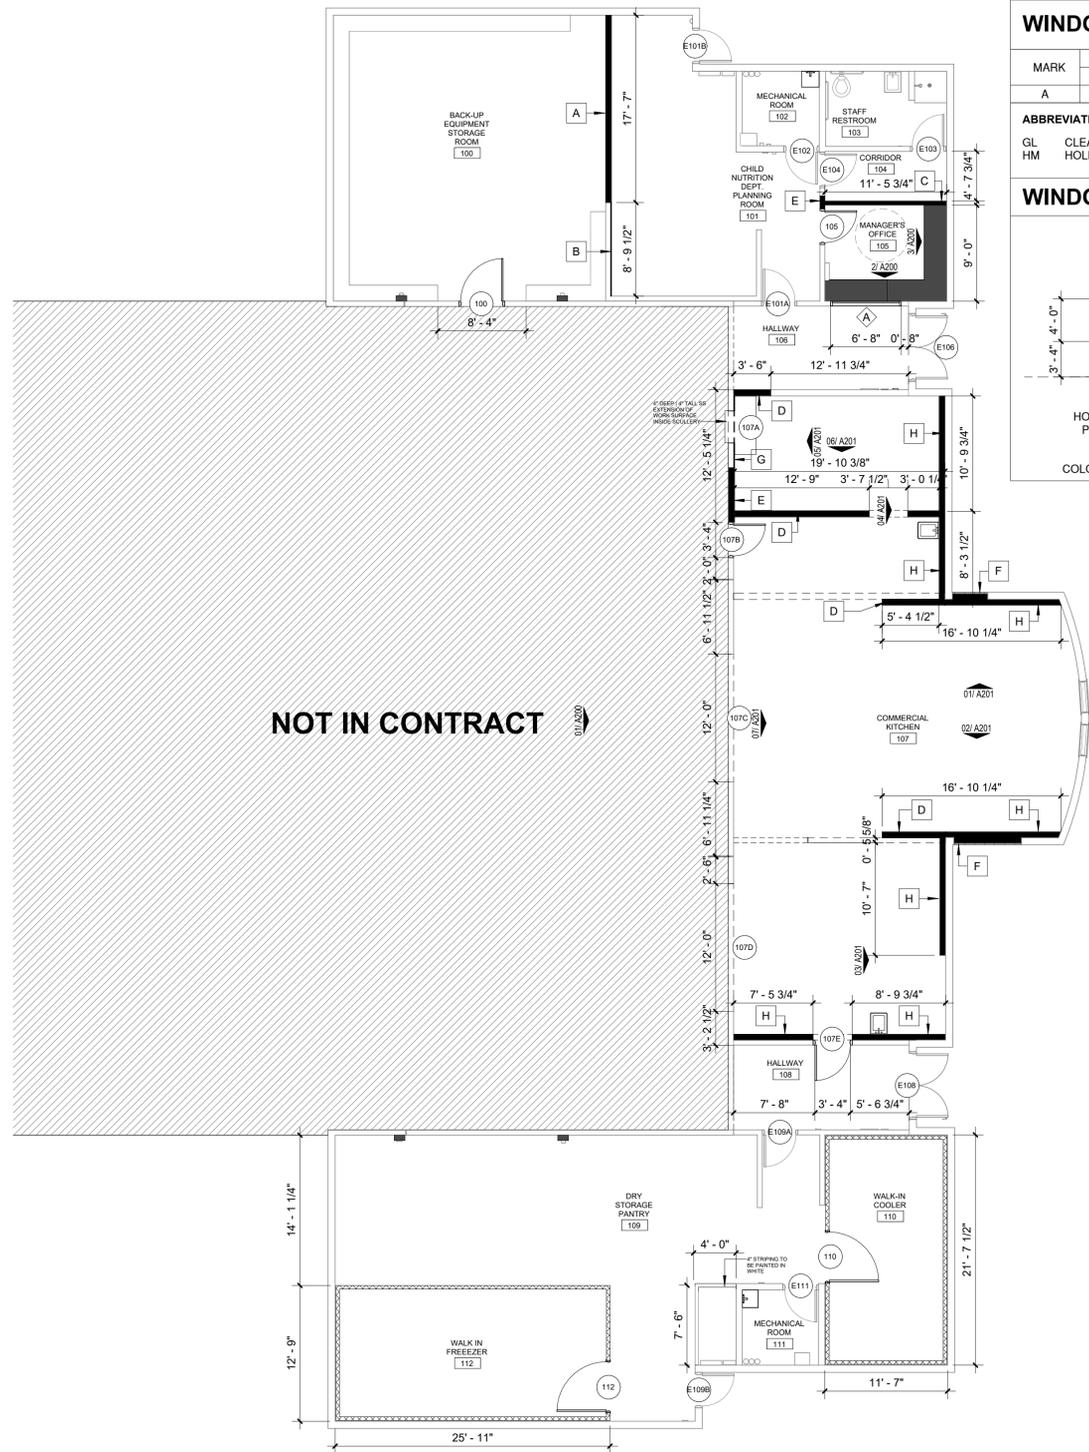MARK	SIZE		TYPE	FRAME MATERIAL	GLAZING	FIRE RATING	DETAIL				NOTES
	WIDTH	HEIGHT					HEAD	JAMB	SILL	MULLION	
A	6'-8"	4'-0"	01	HM	GL	-	01/101	-	01/101	-	2

**ABBREVIATION / MATERIAL LEGEND**  
 GL CLEAR GLAZE  
 HM HOLLOW METAL

**GENERAL NOTES:**  
 1. FIELD VERIFY EXISTING WINDOW OPENING  
 2. REFER TO STRUCTURAL DRAWINGS FOR NEW OPENING DETAILS.

### WINDOW TYPES

**"01"**  
 HOLLOW METAL FRAME  
 PRIME AND PAINTED  
 SINGLE PANE  
 WIRE GLASS  
 COLOR: MATCH WALL BASE

### DOOR SCHEDULE

MARK	TYPE	SIZE			DOOR MATERIAL	DOOR GLASS	FRAME MATERIAL	FRAME			HDW. SET	FIRE RATING	DOOR REMARKS
		W	H	THK				HEAD	JAMB	THRES.			
100	A	4'-0"	7'-0"	1 3/4"	HM	-	HM	06/A101	06/A101	-	SET-01	-	1
E101A	EXIST	-	-	-	EXIST	-	EXIST	-	-	EXIST	SET-01	-	1, 3
E101B	EXIST	-	-	-	EXIST	-	EXIST	-	-	EXIST	-	-	1, 3
E102	EXIST	-	-	-	EXIST	-	EXIST	-	-	EXIST	-	-	1, 3
E103	EXIST	-	-	-	EXIST	-	EXIST	-	-	EXIST	-	-	1, 3
E104	EXIST	-	-	-	EXIST	-	EXIST	-	-	EXIST	-	-	1, 3
105	B	3'-0"	7'-0"	1 3/4"	HM	-	HM	06/A101	06/A101	-	SET-01	-	1
E106	EXIST	-	-	-	EXIST	-	EXIST	-	-	EXIST	-	-	1, 3
107A	D	3'-0"	4'-6"	1 3/4"	-	-	-	03/A101	04/A101	-	-	-	-
107B	B	3'-0"	7'-0"	1 3/4"	HM	-	HM	06/A101	06/A101	-	SET-01	-	1
107C	E	12'-0"	11'-3"	-	-	-	-	01/A101	04/A101	-	-	-	-
107D	F	12'-0"	9'-0"	-	-	-	-	02/A101	04/A101	-	-	-	-
107E	C	3'-8"	7'-0"	1 3/4"	HM	-	HM	06/A101	06/A101	-	SET-01	-	1
E108	EXIST	-	-	-	EXIST	-	EXIST	-	-	EXIST	-	-	3
E109A	EXIST	-	-	-	EXIST	-	EXIST	-	-	EXIST	-	-	3
E109B	EXIST	-	-	-	EXIST	-	EXIST	-	-	EXIST	-	-	3
110	-	-	-	-	-	-	-	-	-	-	-	-	5
E111	EXIST	-	-	-	EXIST	-	EXIST	-	-	EXIST	-	-	3
112	-	-	-	-	-	-	-	-	-	-	-	-	5

### DOOR REMARKS

**GENERAL NOTES:**

- ALL DOORS NOTED ON "DOOR SCHEDULE" SHALL HAVE LEVER HANDLES AND ALL HARDWARE TO MEET ADA REQUIREMENTS, UNLESS OTHERWISE SCHEDULED.
- DOOR MARKED WITH "EXIST" ARE EXISTING DOORS TO REMAIN.
- ALL GLAZING DOORS AND WINDOWS, SHALL BE CLEANED.
- LOCKING DEVICES ON REQUIRED EXIT DOORS SHALL NOT REQUIRED THE USE OF A KEY, OR SPECIAL KNOWLEDGE OR EFFORT FOR OPERATION FROM THE EGRESS SIDE OF THE DOOR, EXCEPT AS SPECIFICALLY PERMITTED BY SECTION 1008.1.3 (2010FBC).

**HARDWARE SET**


**SET - 01**  
 3 STANDARD HINGES MCKINNY, MPB79 4-1/2" \* 4-1/2" US10B  
 SURFACE CLOSER DORMA 38616 AF86P VC 690  
 DOOR HANDLE FALCON B101S GRADE 2 LEVER SET  
 DEADBOLT KWIKSET SINGLE CYLINDER DEADBOLT  
 WITH SMARTKEY MODEL:660-26DSV1  
 KICK PLATE ROCKWOOD #K1050 12"x34"  
 WALL DOOR STOP ROCKWOOD #477 US26D  
 DOOR SILENCER ROCKWOOD #608 SILENCER

**REMARKS KEY NOTES:**

- PRIME AND PAINT HOLLOW METAL FRAMES. COLOR TO MATCH WALL BASE. AT EXTERIOR, MATCH EXISTING.
- VERIFY PROPER OPERATION, PATCH, REPAIR, AND PAINT TO MATCH BASE. ON EXTERIOR SIDES OF DOORS, MATCH EXISTING DOORS.
- DOOR TO BE INSTALLED BY COOLER | FREEZER MANUFACTURER

**ABBREVIATION / MATERIAL LEGEND**

HM	HOLLOW METAL
SC	SOLID CORE, WOOD
GL	CLEAR GLAZE
RB	OIL RUBBED BRONZED

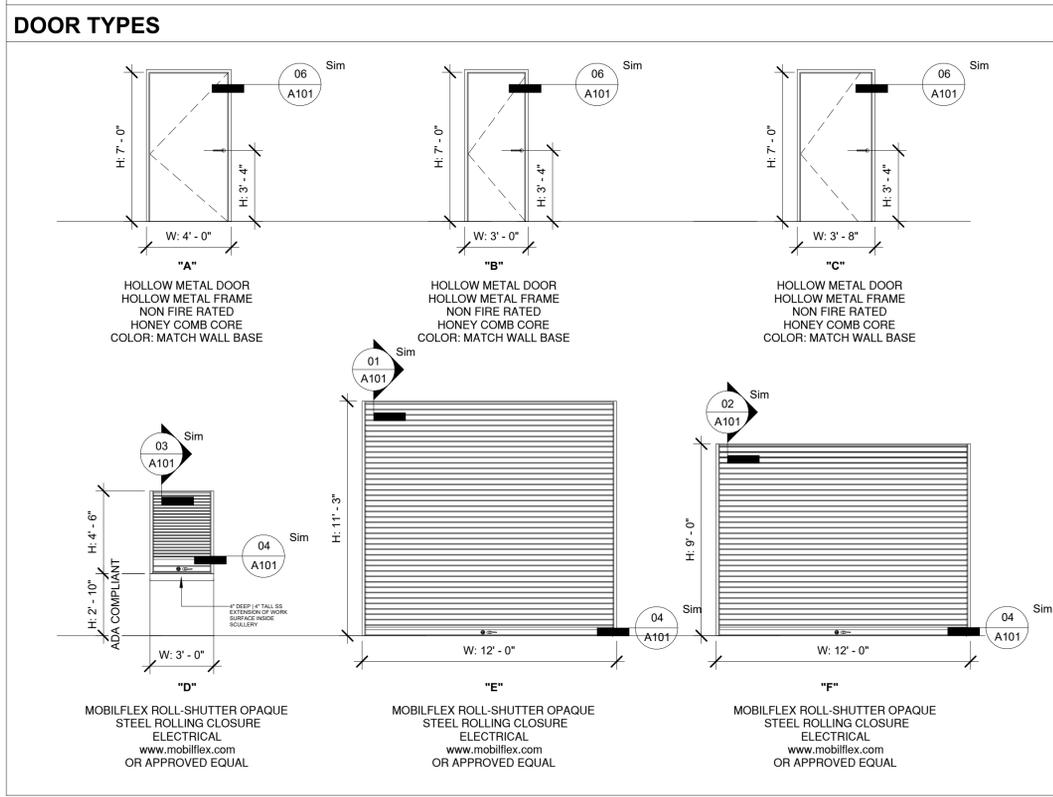

**01 1ST. FLOOR - NEW WORK PLAN**  
 1/8" = 1'-0"



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 Architecture

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 PROJECT NO: 2022-16  
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**REVISION SCHEDULE:**

NO.	DATE	DESCRIPTION

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# TORNILLO INDEPENDENT SCHOOL DISTRICT GYM TO CAFETERIA CONVERSION


300 OIL MILL DR. | TORNILLO, TX 79853

## SHEET TITLE: FLOOR PLAN, DOOR & WINDOW SCHEDULE


CONSTRUCTION DOCUMENTS

**A100**


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**01** DOOR DETAIL - ROLLING CLOSURE - 11' - 3" OPENING  
1" = 1'-0"

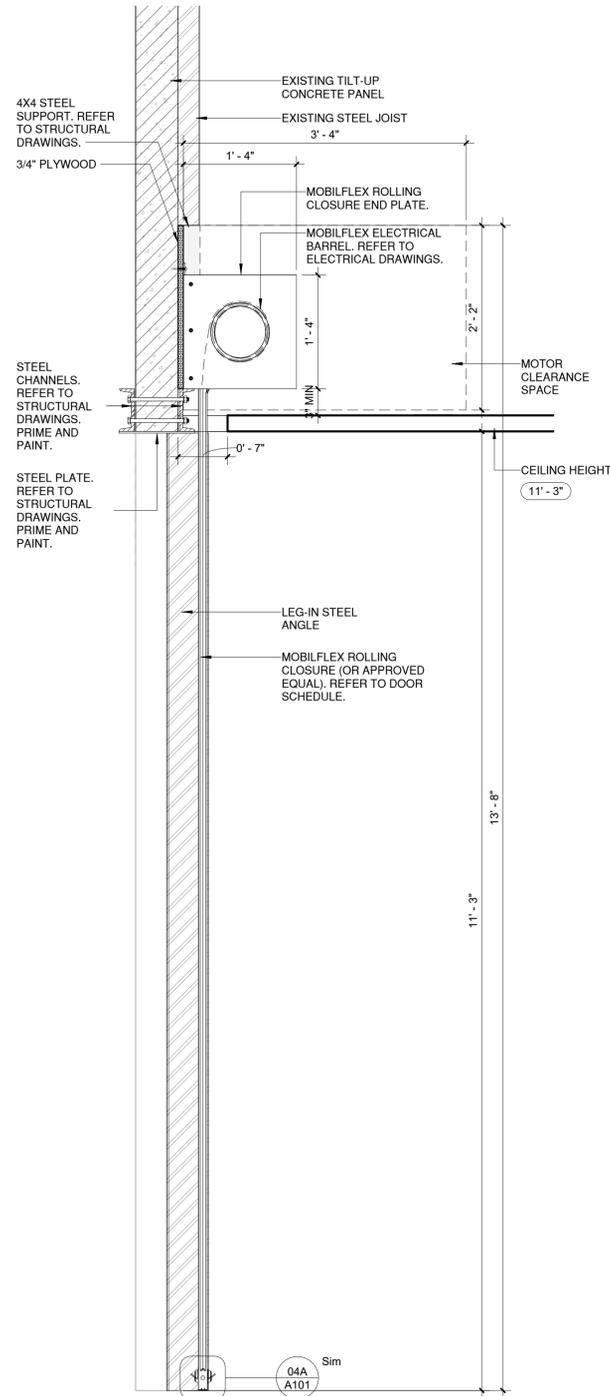

**02** DOOR DETAIL - ROLLING CLOSURE - 9' - 0" OPENING  
1" = 1'-0"

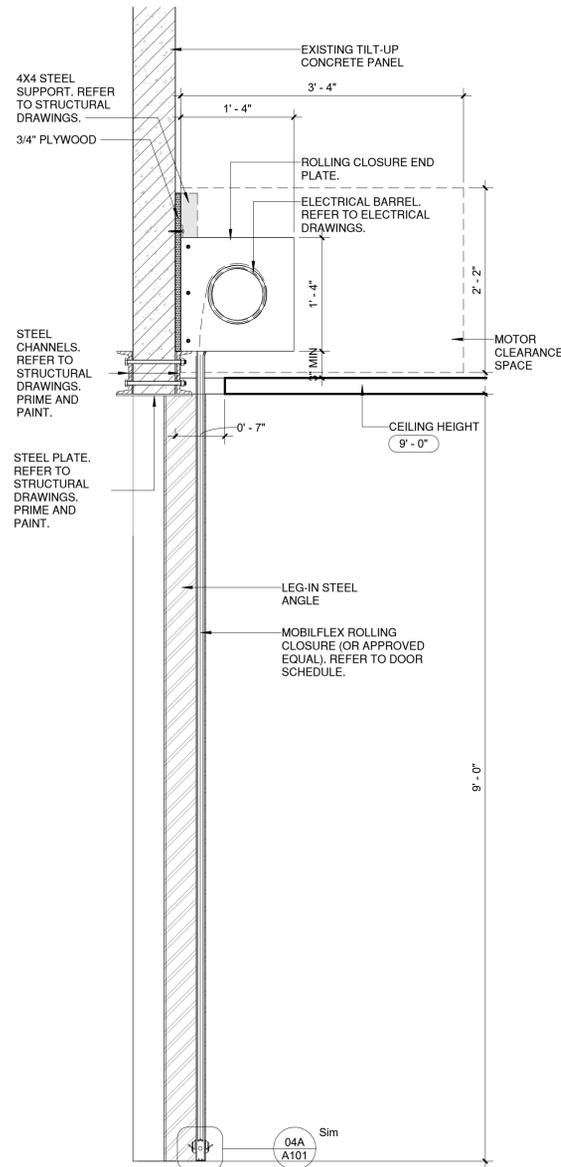


**03** DOOR DETAIL - ROLLING CLOSURE ON COUNTER  
1" = 1'-0"

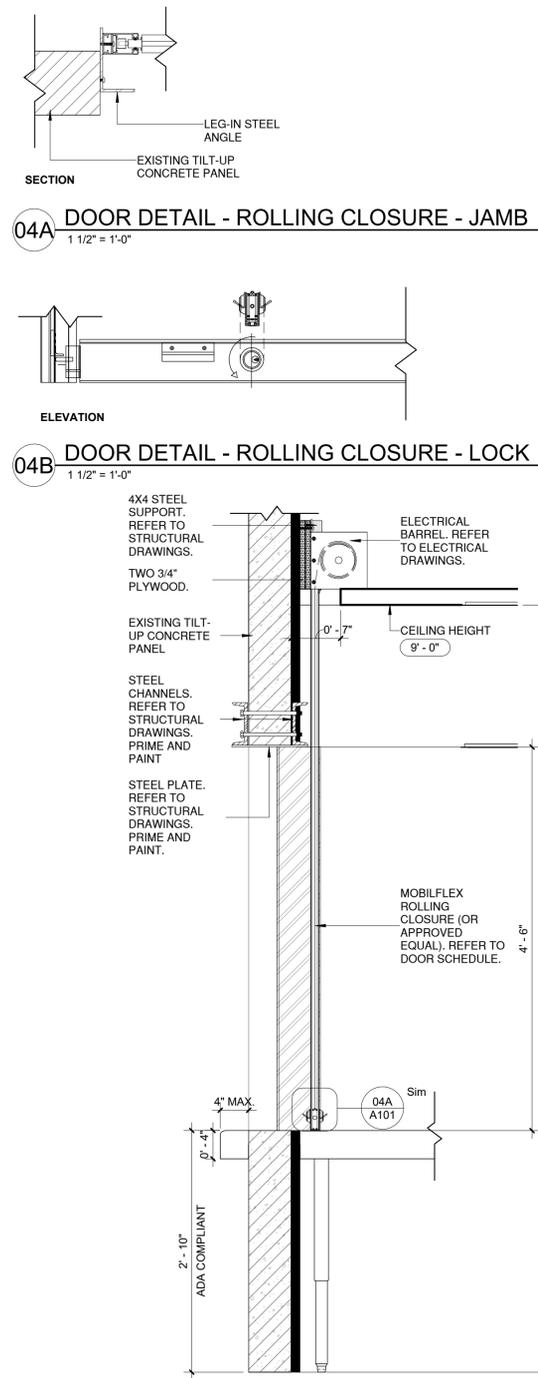
**04A** DOOR DETAIL - ROLLING CLOSURE - JAMB  
1 1/2" = 1'-0"

**04B** DOOR DETAIL - ROLLING CLOSURE - LOCK  
1 1/2" = 1'-0"

**05** WINDOW DETAIL - HOLLOW METAL FRAME  
1 1/2" = 1'-0"

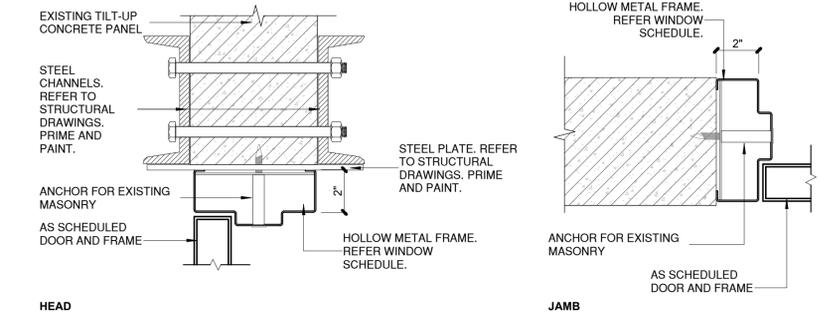

**06** DOOR DETAIL - HOLLOW METAL FRAME  
3" = 1'-0"

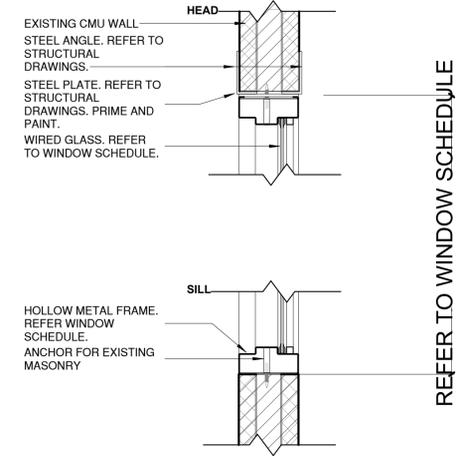

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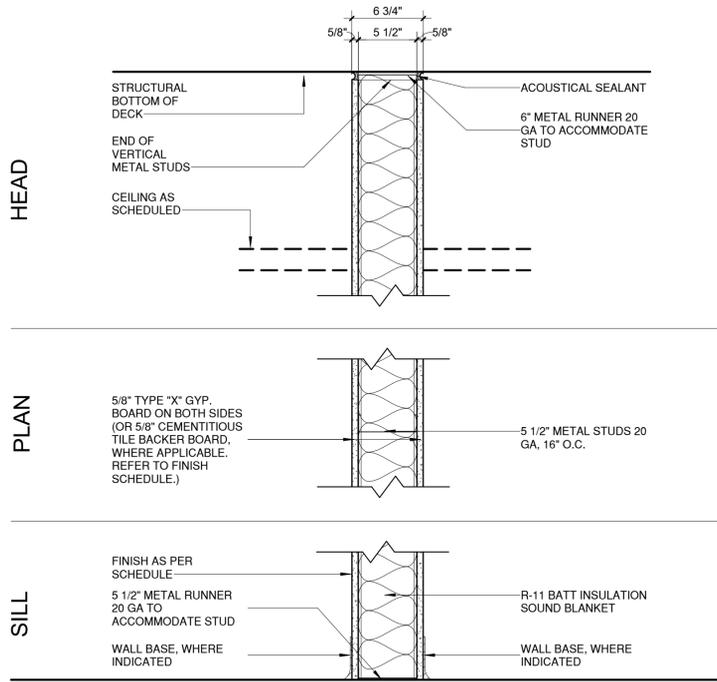
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**GYM TO CAFETERIA CONVERSION**  
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SHEET TITLE:  
**DOOR & WINDOW DETAILS**

CONSTRUCTION DOCUMENTS

**A101**




**A NEW INTERIOR PARTITION WALL**




NOTE: ALL EXPOSED GYPSUM BOARD WALLS & CEILING TO BE FINISHED TO LEVEL 4 PLASTER, ADJOINING AREAS FINISHED TO MATCH.  
 ALL GYPSUM WALL ON THE INTERIOR OF THIS BUILDING SHALL BE PATCHED, FINISHED TO A LEVEL 4 PLASTER FINISH, PRIMED, AND PAINTED WITH NOT LESS THAN TWO COATS OF PAINT.

**B NEW INTERIOR PARTITION WALL**

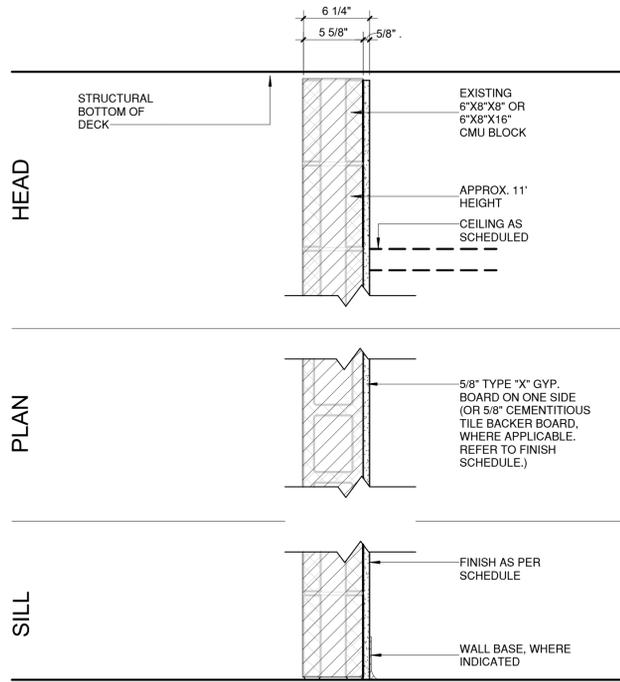


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**C NEW INTERIOR PARTITION WALL**

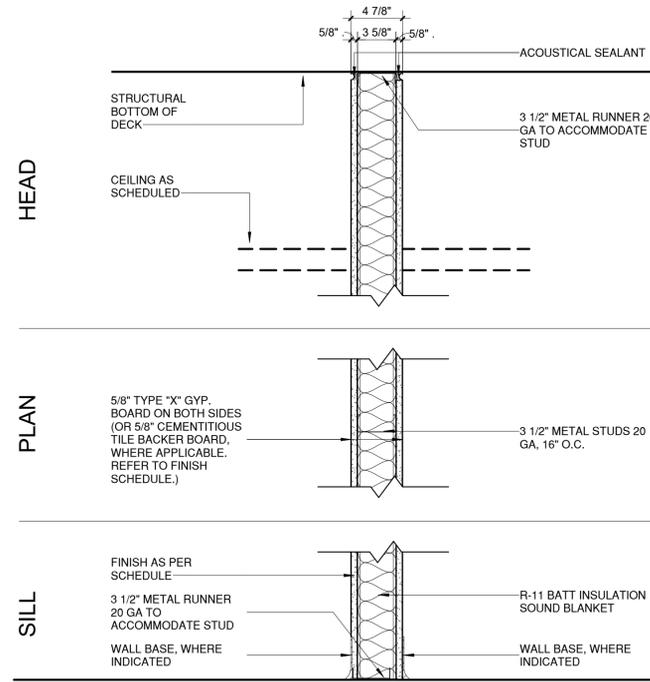


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**D NEW INTERIOR PARTITION WALL**




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**E NEW INTERIOR PARTITION - DOOR AND WINDOW FILL**

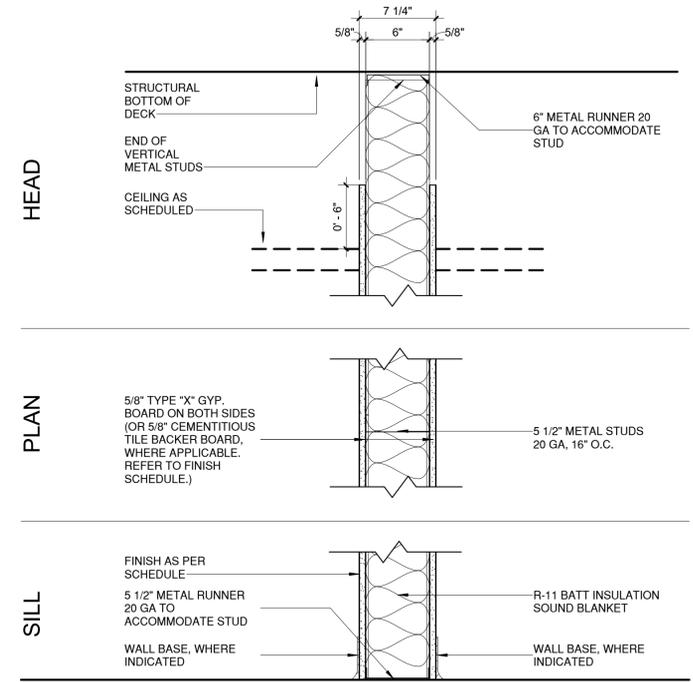


NOTE: ALL EXPOSED GYPSUM BOARD WALLS & CEILING TO BE FINISHED TO LEVEL 4 PLASTER, ADJOINING AREAS FINISHED TO MATCH.  
 ALL GYPSUM WALL ON THE INTERIOR OF THIS BUILDING SHALL BE PATCHED, FINISHED TO A LEVEL 4 PLASTER FINISH, PRIMED, AND PAINTED WITH NOT LESS THAN TWO COATS OF PAINT.  
 NOTE: WIDTH CAN BE ADJUSTED IN THE FIELD TO THE DEPTH OF THE EXISTING WALLS

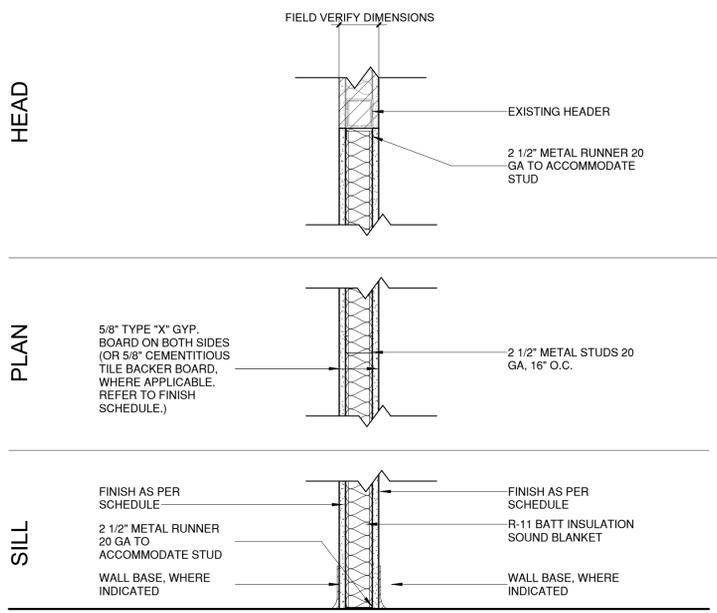**F NEW EXTERIOR WALL - DOOR FILL**

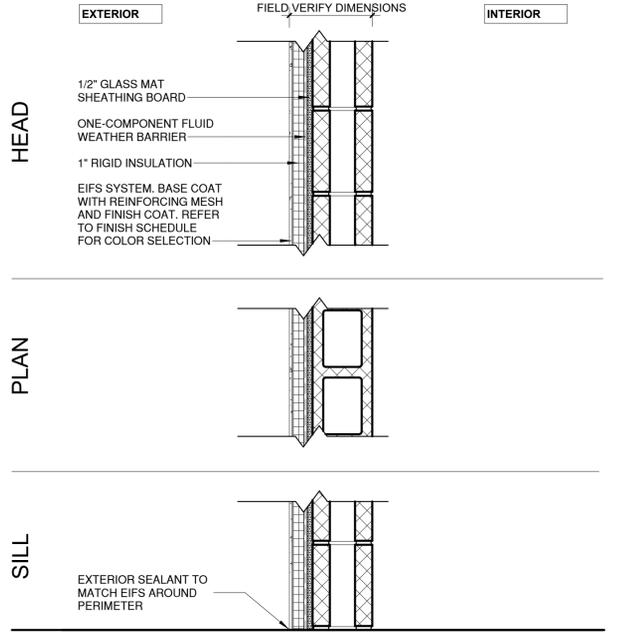


NOTE: WIDTH CAN BE ADJUSTED IN THE FIELD TO THE DEPTH OF THE EXISTING WALLS

**G INTERIOR PARTITION WALL**

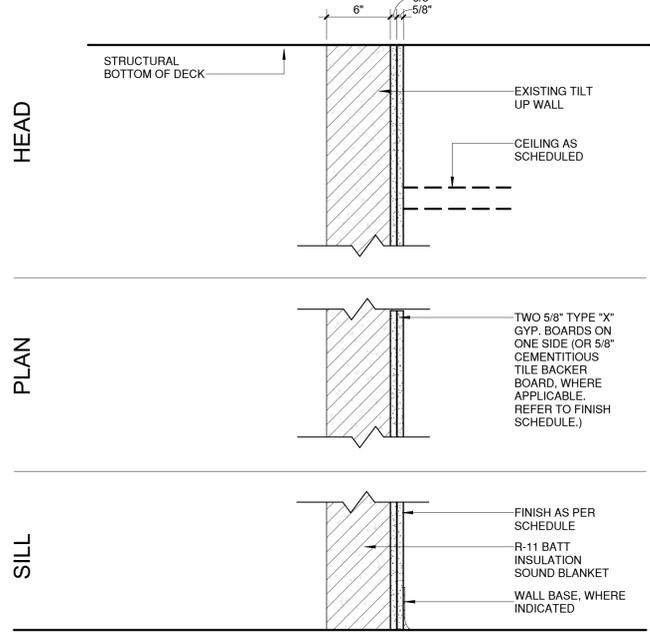

NOTE: ALL EXPOSED GYPSUM BOARD WALLS & CEILING TO BE FINISHED TO LEVEL 4 PLASTER, ADJOINING AREAS FINISHED TO MATCH.  
 ALL GYPSUM WALL ON THE INTERIOR OF THIS BUILDING SHALL BE PATCHED, FINISHED TO A LEVEL 4 PLASTER FINISH, PRIMED, AND PAINTED WITH NOT LESS THAN TWO COATS OF PAINT.

**H NEW INTERIOR PARTITION WALL**

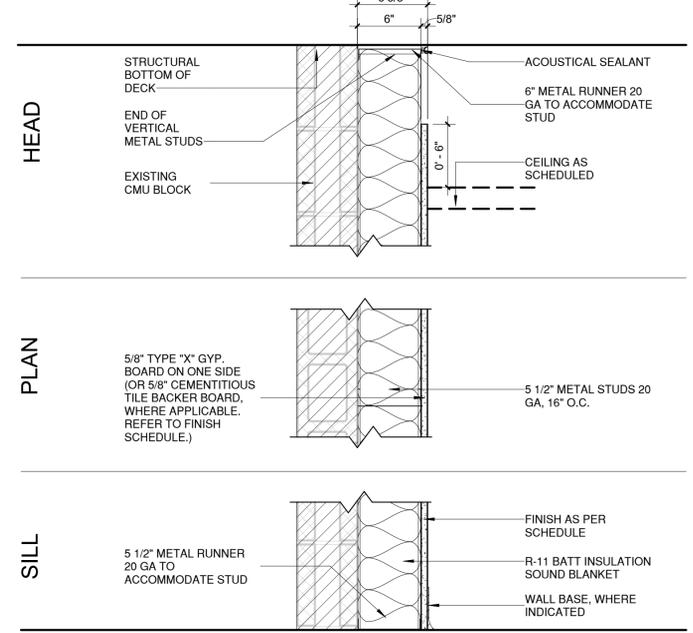

NOTE: ALL EXPOSED GYPSUM BOARD WALLS & CEILING TO BE FINISHED TO LEVEL 4 PLASTER, ADJOINING AREAS FINISHED TO MATCH.  
 ALL GYPSUM WALL ON THE INTERIOR OF THIS BUILDING SHALL BE PATCHED, FINISHED TO A LEVEL 4 PLASTER FINISH, PRIMED, AND PAINTED WITH NOT LESS THAN TWO COATS OF PAINT.

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**TORNILLO INDEPENDENT SCHOOL DISTRICT**  
**GYM TO CAFETERIA CONVERSION**

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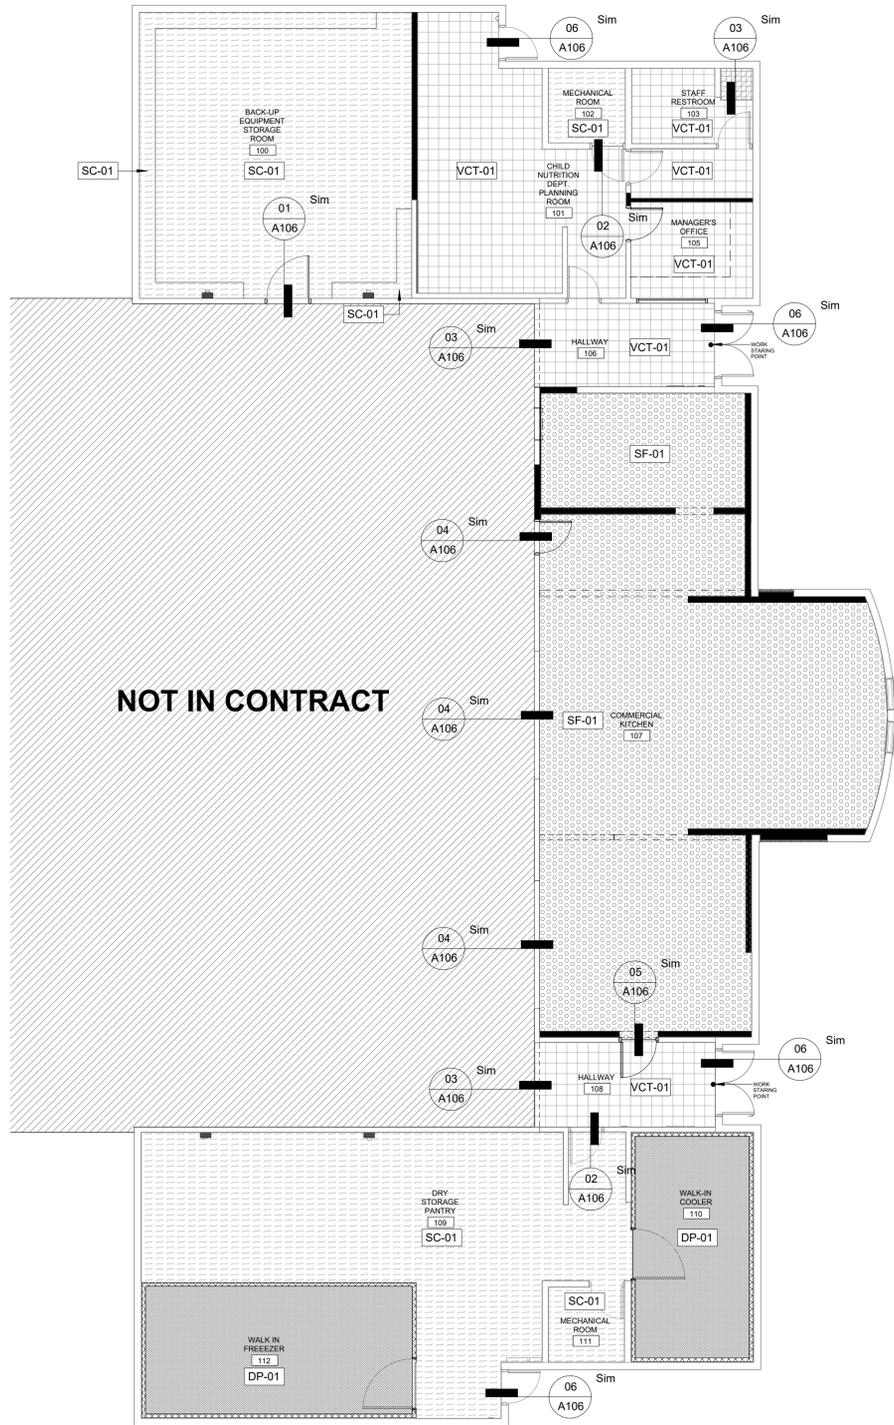
**WALL TYPES**

CONSTRUCTION DOCUMENTS

**A102**

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01 FLOOR FINISHES PLAN  
1/8" = 1'-0"

**FINISH SCHEDULE**

ITEM	DESCRIPTION	MAKE   MODEL	DIMENSIONS	VENDOR	IMAGE	LEGEND	NOTES
<b>FLOOR FINISHES</b>							
SF-01	SAFETY FLOORING	MFR: ALTRO FLOORING COLLECTION:ALTRO CLASSIC 25 COLOR: QUARRY RED X2560R11	ROLLS: 6' - 7' * 49'   2m * 15m THICKNESS: 3.0mm   .12"	www.altrofloors.com			
	COVE BASE		4" OR 6" H				
	ALTRO CAP STRIP C4	TRANSITION DETAIL. RIGID H SHAPED VINYL TRANSITION CAP WITH 8mm SHELF TO BE USED BETWEEN FLASH COVED SHEET FLOORING AND FIBERGLASS REINFORCED PANELS	0.31" W x 1.75" H	www.altrofloors.com			
	ALTRO COVER FORMER	COVER FORMER (COVE STICKS)	0.75" W x 0.75" H	www.altrofloors.com			
VCT-01	VINYL COMPOSITION TILE	MANUFACTURER: ARMSTRONG COLLECTION: PREMIUM EXCELON CROWN TEXTURE COLOR: SMOKEY BROWN 5C868	12" * 12" * 1/8"				
SC-01	POLISHED AND SEALED CONCRETE		0" * 0"				
DP-01	ALUMINUM DIAMOND PLATE. BY COLD STORAGE UNIT SUPPLIER.			BY MANUFACTURER			
	EXISTING TILE TO REMAIN.						

- FINISH SCHEDULE NOTES**
- ALL FINISHES TO BE APPROVED BY OWNER.
  - ALL FINISHES TO BE INSTALLED AS PER THE MANUFACTURER'S INSTRUCTIONS, TO INCLUDE FLOOR PREP.

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DRAWN BY: AL | PJ  
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REVISION SCHEDULE:

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**TORNILLO INDEPENDENT SCHOOL DISTRICT  
GYM TO CAFETERIA CONVERSION**


300 OIL MILL DR. | TORNILLO, TX 79853

SHEET TITLE:  
**FLOOR FINISHES**



CONSTRUCTION DOCUMENTS

**A104**

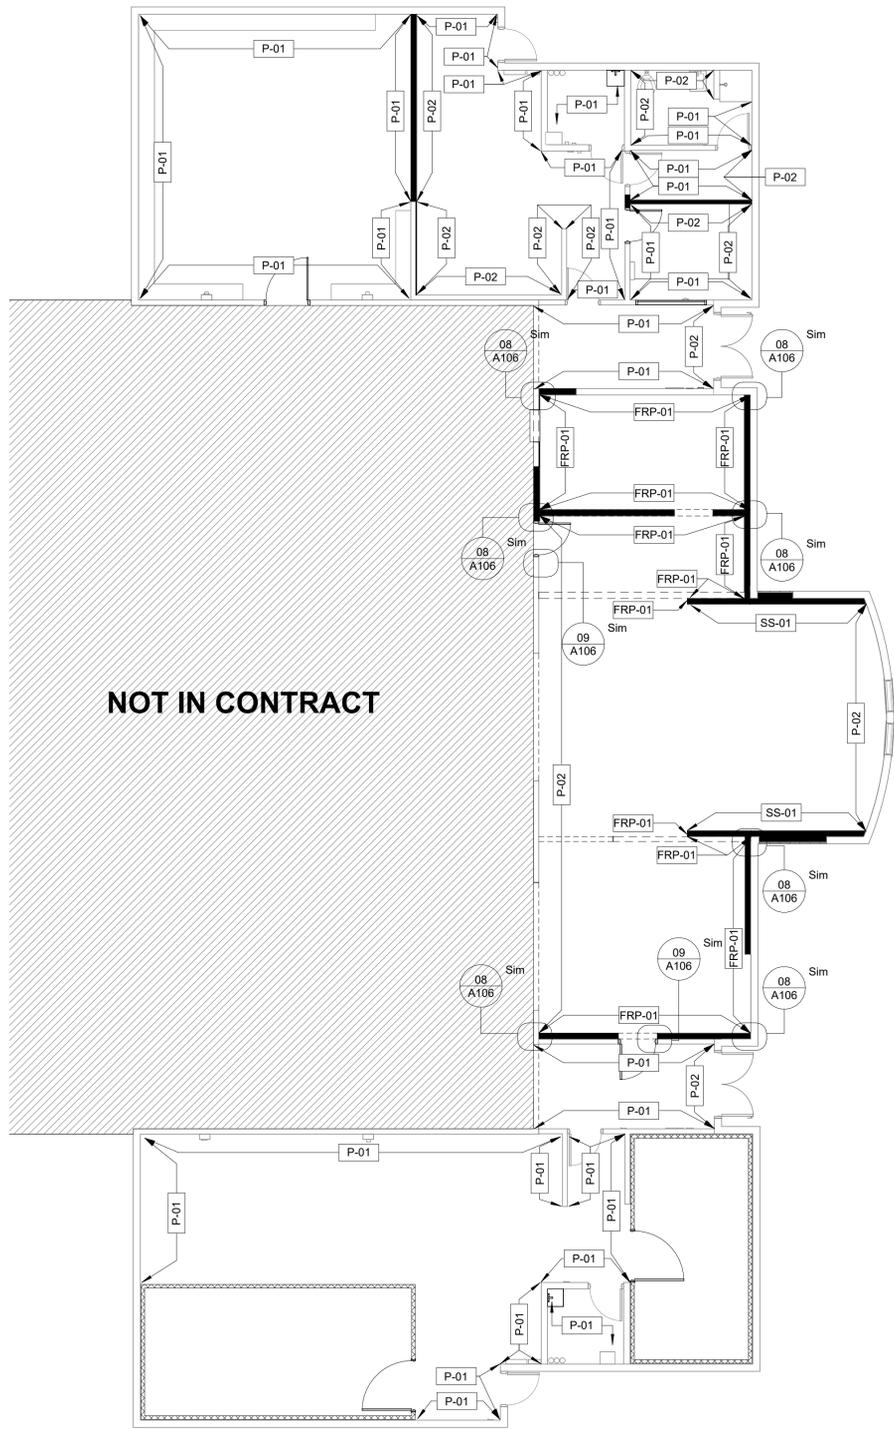

01 WALL FINISHES PLAN  
1/8" = 1'-0"

FINISH SCHEDULE						
ITEM	DESCRIPTION	MAKE   MODEL	DIMENSIONS	VENDOR	LEGEND	NOTES
<b>WALL FINISHES</b>						
P - 01	FIELD COLOR	MFR: SHERWIN WILLIAMS COLOR: AGREEABLE GRAY SW 7029		www.sherwin-williams.com		2
	TRADITIONAL VINYL WALL BASE	MFR: TARKETT MODEL: TRADITIONAL WALL BASE TA4 COLOR: GATEWAY WG	4" H	www.commercial.tarkett.com		
P - 02	ACCENT COLOR	MFR: SHERWIN WILLIAMS COLOR: KEYSTONE GRAY SW 7504		www.sherwin-williams.com		2
	TRADITIONAL VINYL WALL BASE	MFR: TARKETT MODEL: TRADITIONAL WALL BASE TA4 COLOR: GATEWAY WG	4" H	www.commercial.tarkett.com		
FRP-01	FIBERGLASS REINFORCED PANELS					
SS-01	STAINLESS STEEL					
<b>FINISH SCHEDULE NOTES</b>						
1. ALL FINISHES TO BE APPROVED BY OWNER.						
2. TWO PAINTING COATS TO BE APPLIED, MINIMUM.						
3. ALL PAINTINGS AND COATINGS APPLIED SHALL BE APPROPRIATE FOR THE SUBSTRATE, AND SHALL BE APPLIED AS PER THE MANUFACTURER'S INSTRUCTIONS.						

Counryman & Co.  
Architecture

108 SOUTH STANTON, THIRD FLOOR, EL PASO, TEXAS 79901 915.929.1827



DRAWN BY: AL | PJ  
PROJECT NO: 2022-16  
ISSUED: NOVEMBER 1, 2022

REVISION SCHEDULE:

NO.	DATE	DESCRIPTION

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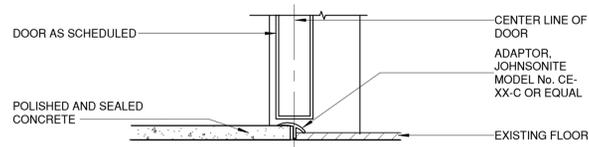
**TORNILLO INDEPENDENT SCHOOL DISTRICT**  
**GYM TO CAFETERIA CONVERSION**  
300 OIL MILL DR. | TORNILLO, TX 79853  
SHEET TITLE:  
**WALL FINISHES**




CONSTRUCTION DOCUMENTS

**A105**


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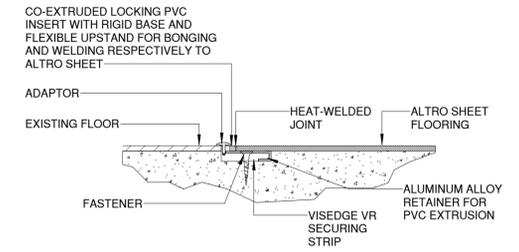
01 FLOOR TRANSITION DETAIL - EXISTING TO SC-01  
3" = 1'-0"




02 FLOOR TRANSITION - SC-01 TO VCT  
3" = 1'-0"

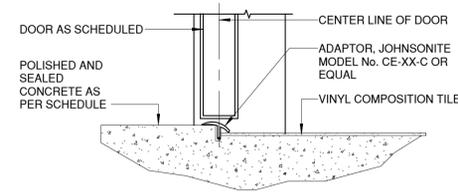


03 FLOOR TRANSITION - EXISTING TO VCT  
3" = 1'-0"

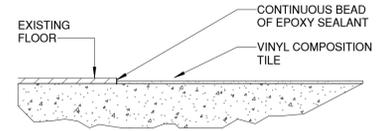


04 FLOOR TRANSITION - EXISTING TO SAFETY FLOORING  
3" = 1'-0"

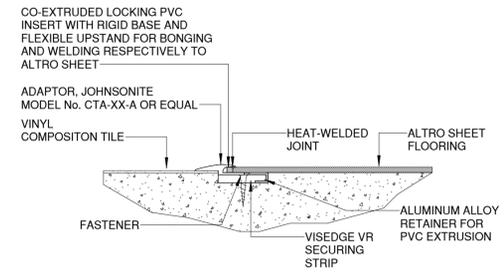


05 FLOOR TRANSITION - VCT TO SAFETY FLOORING  
3" = 1'-0"

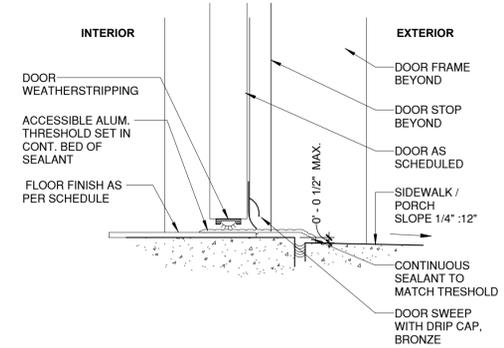


06 THRESHOLD DETAIL  
3" = 1'-0"

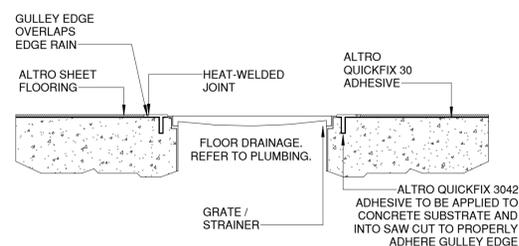


07 ALTRO FLOORING DETAIL - DRAINAGE  
3" = 1'-0"

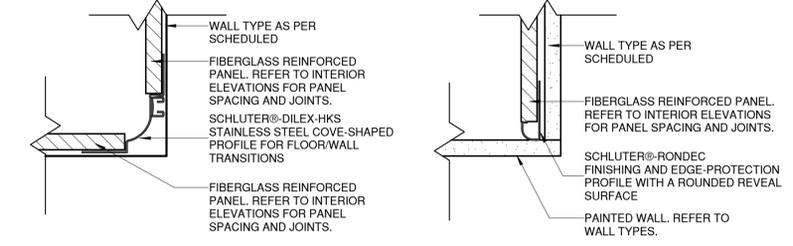

08 FIBERGLASS REINFORCED PANEL - CORNERS DETAIL  
6" = 1'-0"

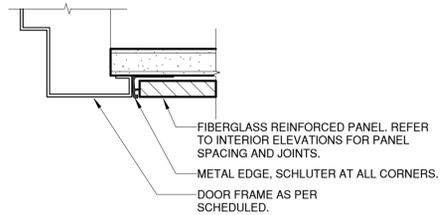

09 FIBERGLASS REINFORCED PANEL - DOOR DETAIL  
6" = 1'-0"

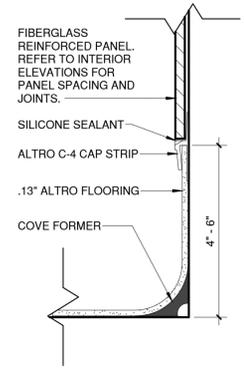

10 COVE BASE DETAIL  
6" = 1'-0"

Countryman & Co.  
Architecture

108 SOUTH STANTON, THIRD FLOOR, EL PASO, TEXAS 79901 915.929.1827



DRAWN BY: AL | PJ  
PROJECT NO: 2022-16  
ISSUED: NOVEMBER 1, 2022

REVISION SCHEDULE:

NO.	DATE	DESCRIPTION

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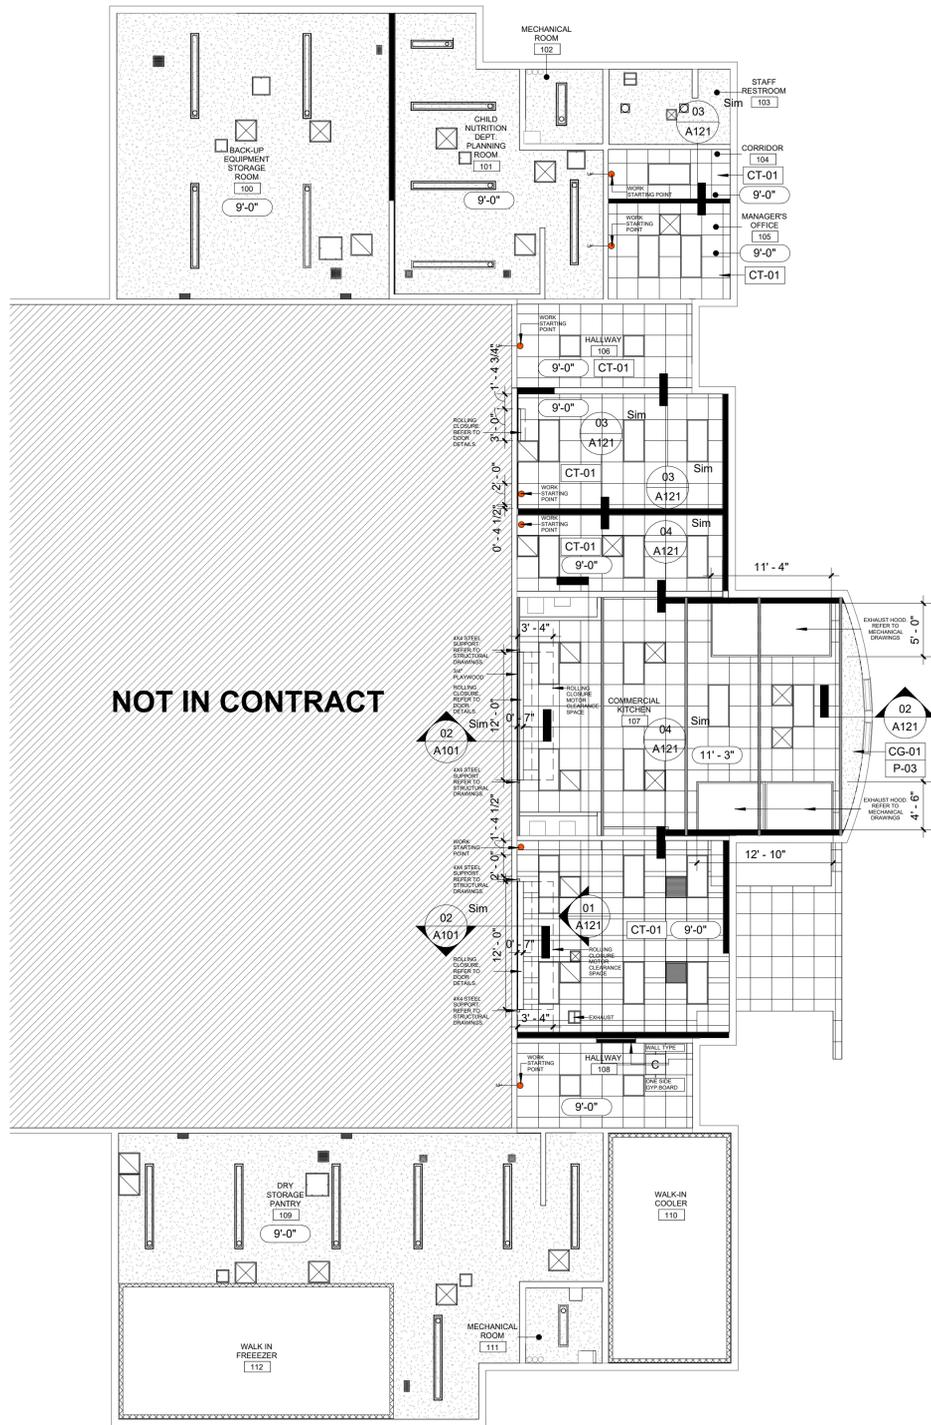
TORNILLO INDEPENDENT SCHOOL DISTRICT  
GYM TO CAFETERIA CONVERSION  
300 OIL MILL DR. | TORNILLO, TX 79853  
SHEET TITLE:  
FINISHES DETAILS



CONSTRUCTION DOCUMENTS

A106

11/01/2022 10:18:03 AM | C:\Users\alvarez\OneDrive - Countryman & Co. Architects\Documents\2022\16\_Tornillo ISD\Drawings\A106\A106.dwg | 11/01/2022 10:18:03 AM



NOT IN CONTRACT

01 REFLECTED CEILING PLAN  
1/8" = 1'-0"

REFLECTED CEILING FINISH SCHEDULE

ITEM	DESCRIPTION	MAKE   MODEL	DIMENSIONS	VENDOR	LEGEND	NOTES
<b>CEILING FINISHES</b>						
CT-01	LAY-IN CEILING	MANUFACTURER: ARMSTRONG MODEL: KITCHEN ZONE	2' x 2'	----		
CG-01	GYP.BD. CEILING	TEXTURE: SMOOTH   LEVEL 4 FINISH: PRIMED AND PAINTED		----		
P-03	CEILING PAINT	MFR: SHERWIN WILLIAMS COLOR: GREEK VILLA SW 7551		----		
<b>LIGHT FIXTURES - REFER TO ELECTRICAL DRAWINGS FOR MORE INFORMATION</b>						
	LAY-IN LED PANEL	LED	2' X 2'	----		
	LAY-IN LED PANEL	LED	2' X 4'	----		
				----		
<b>CEILING SUPPLIES - REFER TO ELECTRICAL AND MECHANICAL DRAWINGS FOR MORE INFORMATION</b>						
	SUPPLY AIR GRILL	----	----	----		
	RETURN AIR GRILL	----	----	----		
	EXHAUST FAN	----	----	----		
	ACCESS DOOR	----	----	----		

CEILING NOTES

1. WORK SHALL FULLY COMPLY WITH GOVERNING CODES, ORDINANCES, RESTRICTIONS, AND NATIONAL ELECTRIC CODE. TAKE ALL NECESSARY SAFETY MEASURES AND COMPLY WITH LOCAL BUILDING DEPARTMENT REQUIREMENTS FOR PUBLIC PROTECTION (BARRICADES, SIGNS, DUST BARRIERS, ETC).
2. GENERAL CONTRACTOR TO CONFIRM HEIGHTS AND COORDINATE WITH EXISTING CONDITIONS. NOTIFY OWNER AND ARCHITECT IF SPECIFIED HEIGHT CANNOT BE ACHIEVED
3. CEILING HEIGHTS ARE TO FINISHES SURFACE. GYPSUM BOARD OR CEILING TILE, AS APPLICABLE.
4. GYPSUM BOARD CEILINGS AND SOFFIT TO HAVE A SMOOTH FINISH UNLESS NOTED OTHERWISE.
5. PAINT HVAC GRILLES TO MATCH ADJACENT CEILING FINISH AND EXISTING TO REMAIN GRILLES.
6. GENERAL CONTRACTOR SHALL MAKE SURE NEW GRILLES OR ADJUSTED GRILLES LOCATIONS DO NOT INTERFERE WITH ANY OTHER CEILING FIXTURES. NOTIFY OWNER AND ARCHITECT IF SPECIFIED LOCATIONS CANNOT BE ACHIEVED .
7. ADJUST EXISTING GRILLES TO MATCH NEW LAY-IN CEILING GRID.
8. THE SUSPENDED TILE CEILING PANELS IN KITCHEN AREAS ARE WASHABLE.
9. REFERENCE MECHANICAL AND ELECTRICAL SHEETS FOR ADDITIONAL INFORMATION AND COORDINATION OF SYSTEMS NOT SHOWN ON THIS PLAN.

Countryman & Co.  
Architecture

108 SOUTH STANTON . THIRD FLOOR . EL PASO, TEXAS 79901 915.929.1827



DRAWN BY: AL | PJ  
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TORNILLO INDEPENDENT SCHOOL DISTRICT  
GYM TO CAFETERIA CONVERSION

300 OIL MILL DR. | TORNILLO, TX 79853


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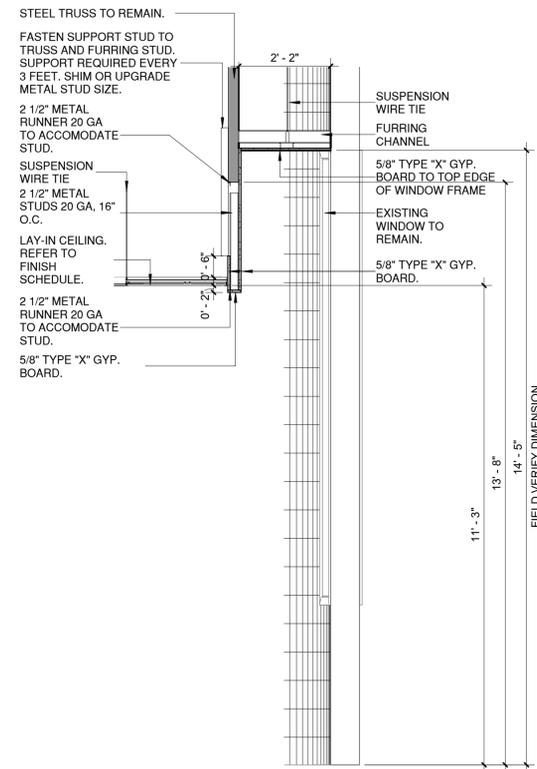


CONSTRUCTION DOCUMENTS


A120




01 CEILING TRANSITION - VERTICAL DUCTWORK CHASE  
1/2" = 1'-0"

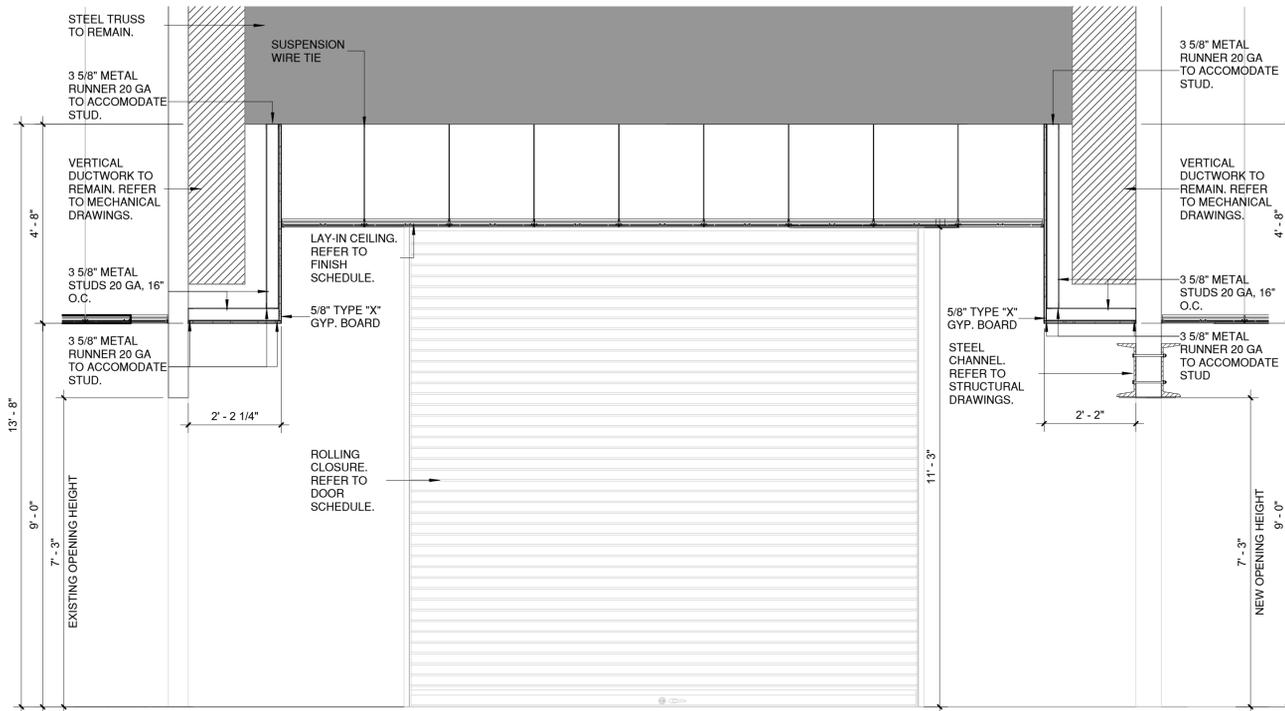

02 CEILING TRANSITION - GYP. BOARD  
1/2" = 1'-0"

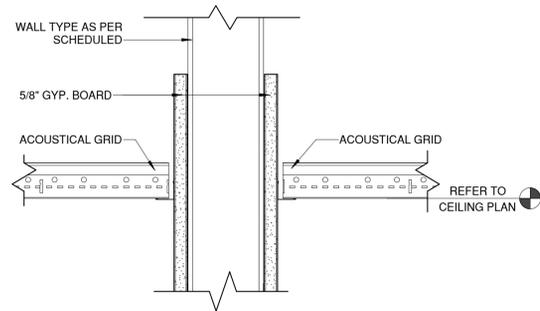

03 CEILING TRANSITION DETAIL - LAY-IN CEILING - EQUAL HEIGHTS  
3" = 1'-0"

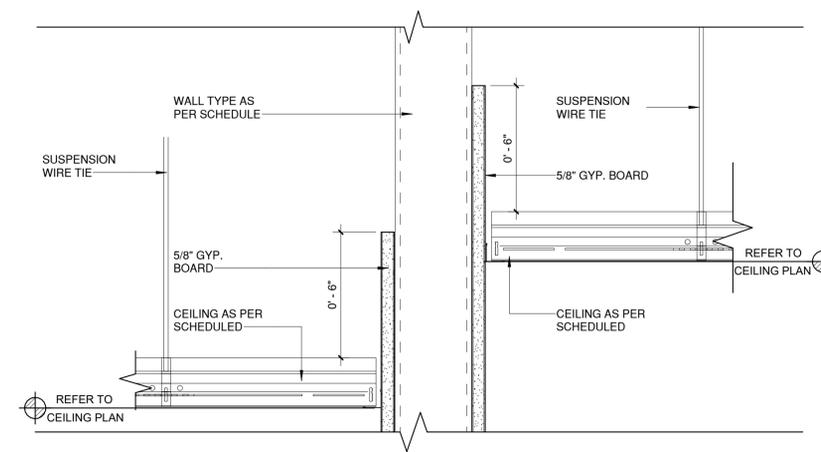

04 CEILING TRANSITION DETAIL - LAY-IN CEILING - CHANGE IN HEIGHTS  
3" = 1'-0"

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Architecture

108 SOUTH STANTON . THIRD FLOOR . EL PASO, TEXAS 79901 915.929.1827



DRAWN BY: PJ  
PROJECT NO: 2022-16  
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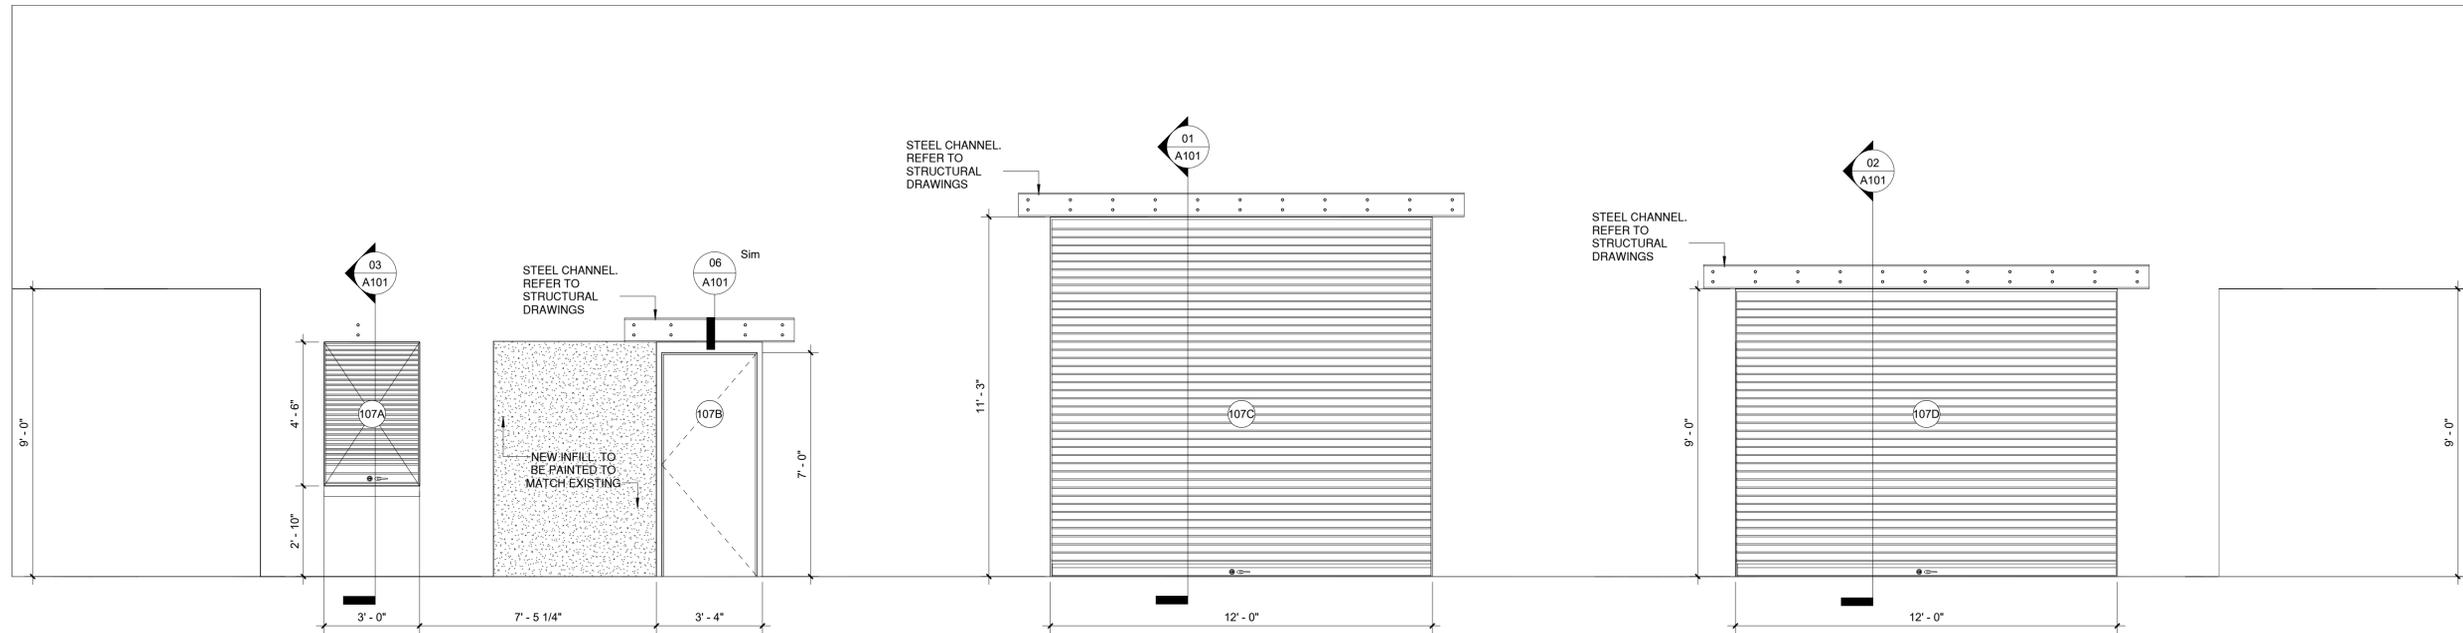
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GYM TO CAFETERIA CONVERSION  
300 OIL MILL DR. | TORNILLO, TX 79853  
SHEET TITLE:  
**CEILING TRANSITION DETAILS**


CONSTRUCTION DOCUMENTS

A121







**01 INTERIOR ELEVATION - NEW OPENINGS**  
3/8" = 1'-0"

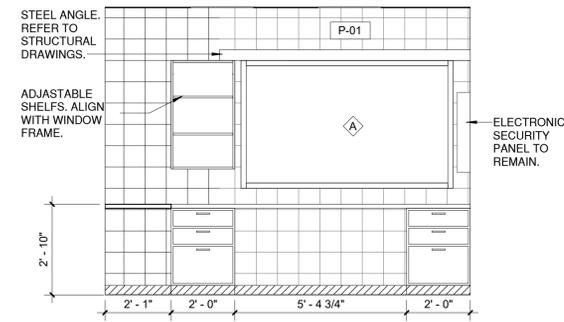

**02 INTERIOR ELEVATION - MANAGER'S OFFICE A**  
3/8" = 1'-0"

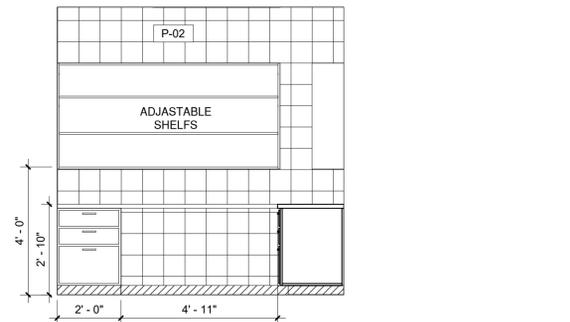

**03 INTERIOR ELEVATION - MANAGER'S OFFICE B**  
3/8" = 1'-0"

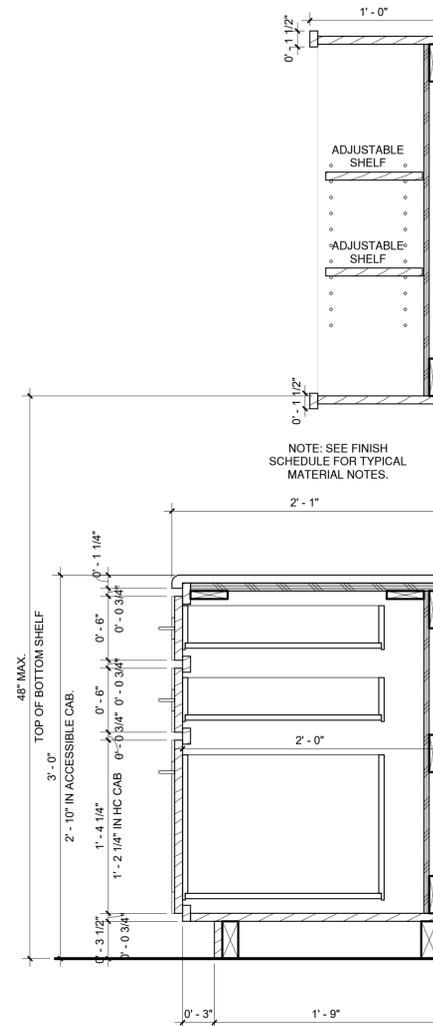

**04 CABINET W/ DRAWERS DETAIL**  
1 1/2" = 1'-0"

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Architecture

108 SOUTH STANTON, THIRD FLOOR, EL PASO, TEXAS 79901 915.929.1827



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**GYM TO CAFETERIA CONVERSION**


300 OIL MILL DR. | TORNILLO, TX 79853

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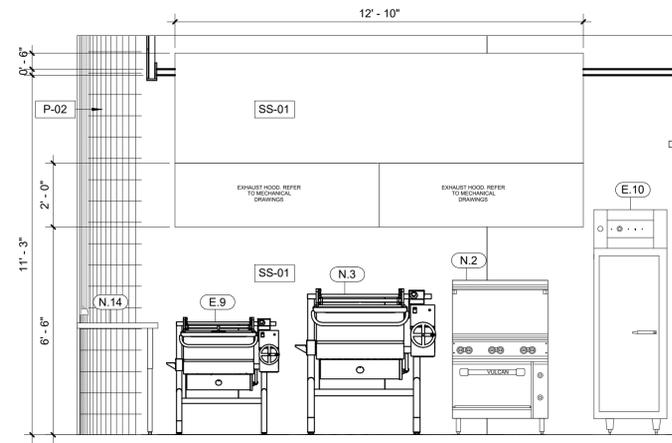
**INTERIOR ELEVATIONS & MILLWORK DETAILS**

CONSTRUCTION DOCUMENTS


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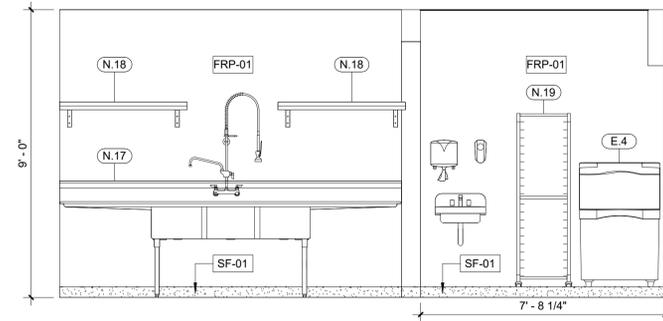
01 KITCHEN ELEVATION A  
3/8" = 1'-0"

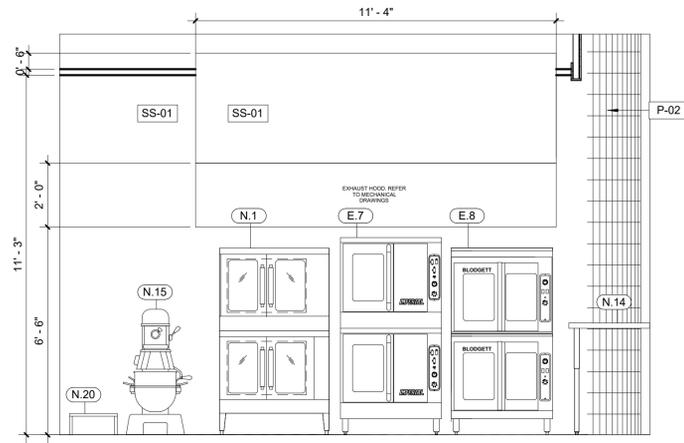


02 KITCHEN ELEVATION B  
3/8" = 1'-0"




03 KITCHEN ELEVATION C  
3/8" = 1'-0"

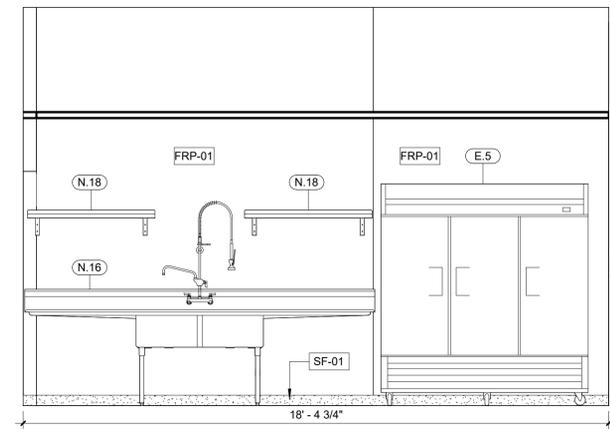


04 KITCHEN ELEVATION D  
3/8" = 1'-0"

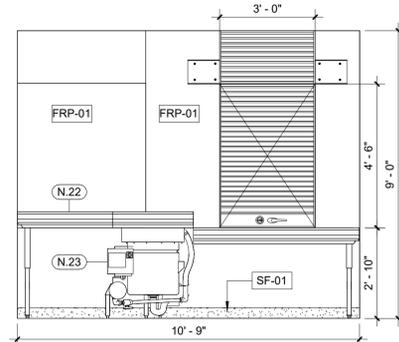

05 KITCHEN ELEVATION E  
3/8" = 1'-0"

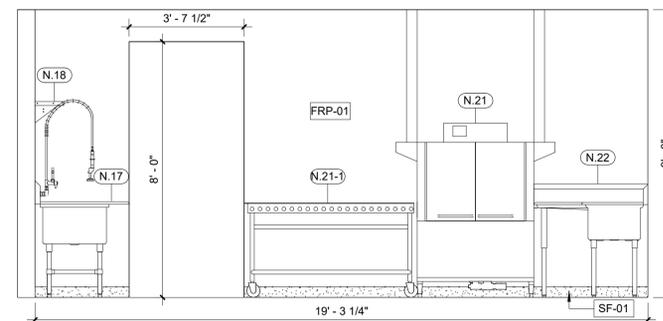

06 KITCHEN ELEVATION F  
3/8" = 1'-0"

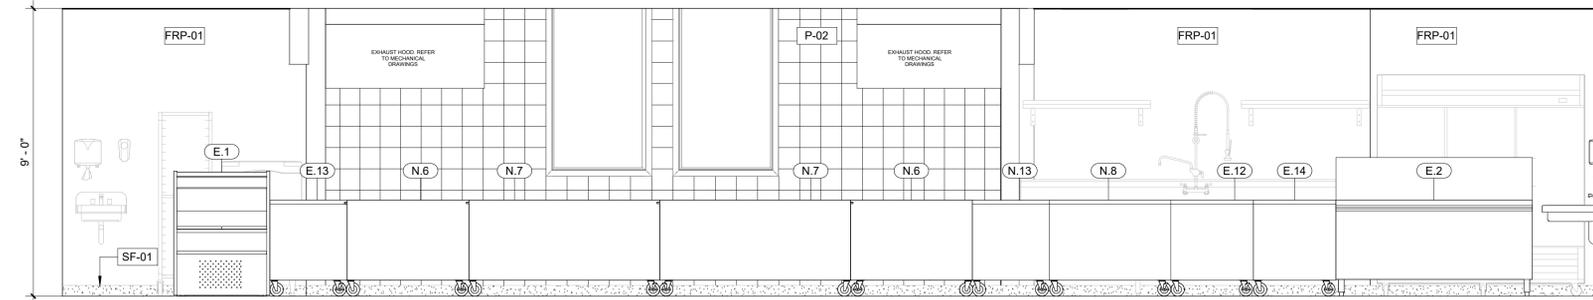

07 KITCHEN ELEVATION G  
3/8" = 1'-0"

FINISH SCHEDULE						
ITEM	DESCRIPTION	MAKE   MODEL	DIMENSIONS	VENDOR	LEGEND	NOTES
<b>WALL FINISHES</b>						
P - 01	FIELD COLOR	MFR: SHERWIN WILLIAMS COLOR: AGREEABLE GRAY SW 7029		www.sherwin-williams.com		2
	TRADITIONAL VINYL WALL BASE	MFR: TARKETT MODEL: TRADITIONAL WALL BASE TA4 COLOR: GATEWAY WG	4" H	www.commercial.tarkett.com		
P - 02	ACCENT COLOR	MFR: SHERWIN WILLIAMS COLOR: KEYSTONE GRAY SW 7504		www.sherwin-williams.com		2
	TRADITIONAL VINYL WALL BASE	MFR: TARKETT MODEL: TRADITIONAL WALL BASE TA4 COLOR: GATEWAY WG	4" H	www.commercial.tarkett.com		
FRP-01	FIBERGLASS REINFORCED PANELS					
SS-01	STAINLESS STEEL					
<b>FINISH SCHEDULE NOTES</b>						
1. ALL FINISHES TO BE APPROVED BY OWNER.						
2. TWO PAINTING COATS TO BE APPLIED, MINIMUM.						
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Countryman & Co.  
Architecture

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GYM TO CAFETERIA CONVERSION

300 OIL MILL DR. | TORNILLO, TX 79853

SHEET TITLE:

KITCHEN INTERIOR ELEVATIONS

CONSTRUCTION  
DOCUMENTS

A201



# GENERAL STRUCTURAL NOTES

## GENERAL

- THESE DRAWINGS HAVE BEEN PREPARED USING STANDARDS OF PROFESSIONAL CARE AND COMPLETENESS NORMALLY EXERCISED UNDER SIMILAR CIRCUMSTANCES BY REPUTABLE STRUCTURAL ENGINEERS IN THIS OR SIMILAR LOCALITIES. THEY ASSUME THAT THE WORK DEPICTED WILL BE PERFORMED BY AN EXPERIENCED CONTRACTOR AND/OR WORKERS WHO HAVE A WORKING KNOWLEDGE OF THE APPLICABLE CODE STANDARDS AND REQUIREMENTS AND OF INDUSTRY ACCEPTED STANDARD GOOD PRACTICE AS NOT EVERY CONDITION OR ELEMENT IS (OR CAN BE) EXPLICITLY SHOWN ON THESE DRAWINGS. THE CONTRACTOR SHALL USE INDUSTRY ACCEPTED STANDARD GOOD PRACTICE FOR MISCELLANEOUS WORK NOT EXPLICITLY SHOWN.
- THESE DRAWINGS REPRESENT THE FINISHED STRUCTURE. THEY DO NOT INDICATE THE METHOD OF CONSTRUCTION. THE CONTRACTOR SHALL BE SOLELY RESPONSIBLE FOR CONSTRUCTION MEANS, METHODS, TECHNIQUES, SEQUENCES, PROCEDURES, LAGGING, SHORING, BRACING, FORM-WORK, ETC. AS REQUIRED FOR THE PROTECTION OF LIFE AND PROPERTY DURING CONSTRUCTION. CONSTRUCTION MATERIALS SHALL BE UNIFORMLY SPREAD OUT SUCH THAT DESIGN LIVE LOAD PER SQUARE FOOT AS NOTED HEREIN IS NOT EXCEEDED.
- DESIGN OF ITEMS NOT PART OF THE PRIMARY STRUCTURAL SYSTEM (SUCH AS EXTERIOR PAVING, RAILINGS, NON-STRUCTURAL WALLS) AND PREFABRICATED STRUCTURAL ITEMS (SUCH AS FLOOR, ROOF TRUSSES) SHALL BE PROVIDED BY OTHERS UNLESS SPECIFICALLY NOTED ON THESE DRAWINGS.
- THE CONTRACTOR SHALL VERIFY ALL DIMENSIONS, CONDITIONS AND ELEVATIONS WITH ARCHITECTURAL DRAWINGS AND RESOLVE ANY DISCREPANCIES WITH THE ARCHITECT PRIOR TO START OF CONSTRUCTION. CONTRACTOR SHALL ESTABLISH AND VERIFY ALL OPENINGS AND INSERTS FOR ARCHITECTURAL, MECHANICAL, PLUMBING AND ELECTRICAL WITH APPROPRIATE TRADES, DRAWINGS AND SUBCONTRACTORS PRIOR TO CONSTRUCTION.
- TYPICAL DETAILS AND NOTES SHALL APPLY, THOUGH NOT NECESSARILY INDICATED AT A SPECIFIC LOCATION ON PLANS. WHERE NO DETAILS ARE SHOWN, CONSTRUCTION SHALL CONFORM TO SIMILAR WORK ON THE PROJECT. DETAILS MAY SHOW ONLY ONE SIDE OF CONNECTION OR MAY OMIT INFORMATION FOR CLARITY.
- NOTES AND DETAILS ON DRAWINGS SHALL TAKE PRECEDENCE OVER GENERAL STRUCTURAL NOTES AND TYPICAL DETAILS.
- ALL INSPECTIONS REQUIRED BY THE BUILDING CODES, JURISDICTION, OR THESE PLANS SHALL BE PROVIDED BY AN INDEPENDENT INSPECTION COMPANY OR THE BUILDING DEPARTMENT. SITE VISITS BY THE ENGINEER DO NOT CONSTITUTE AN INSPECTION.

## BASIS FOR DESIGN

BUILDING CODES:	IBC 2015 ASCE 7-10 AISC 14TH EDITION
LIVE LOADS:	ROOF = 20 PSF
WIND LOADS:	120 MPH EXPOSURE B COEFFICIENT (GCp) = 0.18
SNOW LOADS:	GROUND SNOW LOAD = 5 PSF
SEISMIC LOADS:	EQUIVALENT LATERAL FORCE PROCEDURE SEISMIC DESIGN CATEGORY = C SITE CLASS D S <sub>s</sub> = 0.360 S <sub>1</sub> = 0.108 S <sub>0.5</sub> = 0.363 S <sub>0.1</sub> = 0.017
RISK CATEGORY:	CATEGORY III SEISMIC IMPORTANCE FACTOR = 1.25

## CONCRETE

- ALL CONCRETE CONSTRUCTION SHALL BE PERFORMED IN ACCORDANCE WITH ACI 318 AND ACI 301.
- MIN. 28 DAY COMPRESSIVE STRENGTH,  $f_c$ , AND LARGEST NOMINAL AGGREGATE SIZE SHALL BE AS NOTED BELOW. MAX. WATER/CEMENT RATIO FOR CONCRETE IN CONTACT WITH SOIL SHALL BE 0.45.
- CONCRETE MIXES SHALL BE DESIGNED BY A CERTIFIED LABORATORY, STAMPED BY AN APPROPRIATELY LICENSED SPECIALTY ENGINEER, AND APPROVED BY THE ENGINEER OF RECORD. MIX DESIGNS SHALL INCLUDE THE PROJECT NAME AND INDICATE THEIR USE WITHIN THE STRUCTURE. MIX DESIGNS SHALL BE PROPORTIONED TO MINIMIZE SHRINKAGE AND HAVE PROVEN SHRINKAGE CHARACTERISTICS OF 0.05% OR LESS BASED ON TESTING PER ASTM C157.
- IF USED, EARLY STRENGTH CONCRETE SHALL BE PROPORTIONED TO DEVELOP THE 28 DAY COMPRESSIVE STRENGTH AT THE AGE REQUIRED BY THE CONTRACTOR. CONTRACTOR SHALL SUBMIT TEST DATA FOR REVIEW BY THE ENGINEER OF RECORD TO SUBSTANTIATE THE CONCRETE STRENGTH AT THE REQUIRED AGE.
- ALL CONCRETE SHALL BE NORMAL WEIGHT OF 145 POUNDS PER CUBIC FOOT USING HARD ROCK AGGREGATES CONFORMING TO ASTM C33 U.N.O. WHERE LIGHTWEIGHT CONCRETE IS SPECIFIED, CONCRETE SHALL BE 110 POUNDS PER CUBIC FOOT USING AGGREGATES CONFORMING TO ASTM C330.
- MAX. SLUMP SHALL BE 5 INCHES (EXCEPTION: WHERE ADMIXTURES/PLASTICIZERS HAVE BEEN INCLUDED IN MIX DESIGN TO IMPROVE WORKABILITY, SLUMP LIMIT SHALL BE BASED ON ADMIXTURE MFR'S RECOMMENDATIONS). MIX WATER SHALL BE CLEAN AND POTABLE.
- PORTLAND CEMENT SHALL CONFORM TO ASTM C150. TYPE II CEMENT MAY BE USED. CEMENT SHALL BE TYPE V WITH POZZOLAN WHERE CONCRETE IS IN CONTACT WITH SOIL CONTAINING VERY SEVERE SULFATE EXPOSURE.
- WATER SOLUBLE CHLORIDE ION CONCENTRATIONS IN CONCRETE SHALL BE LIMITED PER ACI 318, SECTION 4.3, EXPOSURE CLASS "C1".
- CONCRETE MIXING, PLACEMENT AND QUALITY SHALL BE PER ACI 318. MECHANICALLY VIBRATE ALL CONCRETE WHEN PLACED. UNCONFINED FALL OF CONCRETE SHALL NOT EXCEED 5 FEET.
- PROTECT CONCRETE FROM DAMAGE OR REDUCED STRENGTH DUE TO COLD OR HOT WEATHER IN ACCORDANCE WITH ACI 305 AND 306. CONTRACTOR SHALL TAKE SPECIAL CURING PRECAUTIONS TO MINIMIZE SHRINKAGE CRACKING OF CONCRETE SLABS.
- ALL ITEMS TO BE CAST IN CONCRETE SUCH AS REINFORCEMENT, DOWELS, BOLTS, ANCHORS, SLEEVES, ETC., SHALL BE SECURELY POSITIONED IN THE FORMS.
- FLY ASH MAY BE USED IN CONCRETE. SUBJECT TO APPROVAL BY THE ARCHITECT, PROVIDED THE FOLLOWING CONDITIONS ARE MET:
  - FLY ASH SHALL COMPLY 8.1. WITH ASTM C618.
  - CEMENT CONTENT SHALL BE REDUCED A MINIMUM OF 15 PERCENT UP TO A MAXIMUM OF 25 PERCENT WHEN COMPARED TO AN EQUIVALENT CONCRETE MIX DESIGN WITHOUT FLY ASH. FLY ASH CONTENT SHALL NOT COMPRISE MORE THAN 35 PERCENT OF THE TOTAL CEMENTITIOUS CONTENT. THE WATER-CEMENT RATIO SHALL BE CALCULATED BASED ON THE TOTAL CEMENTITIOUS MATERIAL IN THE MIX.
  - CLASS F FLY ASH SHALL BE USED IN SULFATE RESISTANT CONCRETE WITH  $f_c$  EQUAL TO OR GREATER THAN 4000 PSI. CLASS C FLY ASH MAY BE USED ELSEWHERE.

## CONCRETE PORTIONING

LOCATION IN STRUCTURE	STRENGTH	LARGEST AGGREGATE SIZE
FOOTINGS & SLAB	3000 PSI	3/4" MIN 1 1/2" MAX

## STRUCTURAL STEEL

- ALL STRUCTURAL AND MISC. STEEL SHALL BE FABRICATED AND ERECTED IN ACCORDANCE WITH AISC 303.
  - ASTM A6 HOT-ROLLED SHAPES WITH FLANGE THICKNESS EXCEEDING 2" SHALL BE SUPPLIED WITH CHARPY V-NOTCH TESTING IN ACCORDANCE WITH ASTM A6. SUPPLEMENTARY REQUIREMENT S30. IMPACT TESTS SHALL MEET A MINIMUM AVERAGE TOUGHNESS OF 20 FT-LB AT 70 °F. SPLICES, WELD ACCESS HOLES, COMPATIBLE WELDING PROCEDURES, WELDING PREHEAT REQUIREMENTS, AND THERMAL CUT SURFACE PREPARATION AND INSPECTION SHALL BE MADE IN ACCORDANCE WITH SECTIONS J1.5, J1.6, J2.7, AND M2.2 OF AISC 360. WELD TABS AND BACKING AT SPLICES SHALL BE REMOVED AND THE SURFACES GROUND SMOOTH.
  - SHEAR CONNECTORS (SUCH AS HEADED STEEL STUDS, STEEL BARS, OR STEEL LUGS), REINFORCING BARS, DEFORMED ANCHORS, OR THREADED STUDS SHALL NOT BE ATTACHED TO THE TOP FLANGES OF BEAMS, JOISTS, OR BEAM ATTACHMENTS SO THAT THEY PROJECT VERTICALLY FROM OR HORIZONTALLY ACROSS THE TOP FLANGE OF THE MEMBER UNTIL AFTER THE METAL DECKING, OR OTHER WALKING/WORKING SURFACE, HAS BEEN INSTALLED.
  - STRUCTURAL STEEL MEMBERS SHALL CONFORM TO THE FOLLOWING STANDARDS AND MATERIAL PROPERTIES U.N.O.:
- | SHAPE   | STANDARD           | F <sub>y</sub> |
|---|--------------------|----------------|
| ROLLED WIDE FLANGE SECTIONS                     | ASTM A992          | 50 KSI         |
| OTHER STANDARD STEEL SHAPES AND ROLLED SECTIONS | ASTM A36           | 36 KSI         |
| BARS AND PLATES                                 | ASTM A36           | 36 KSI         |
| PIPES   | ASTM A53, GRADE B  | 36 KSI         |
| HOLLOW STRUT. SECTIONS (RECT.)                  | ASTM A500, GRADE B | 46 KSI         |
| HOLLOW STRUCT. SECTIONS (ROUND)                 | ASTM A500, GRADE B | 42 KSI         |


## REINFORCING STEEL

- REINFORCING STEEL SHALL BE DETAILED AND PLACED IN ACCORDANCE WITH ACI 318 AND CRSI'S MANUAL OF STANDARD PRACTICE.
- REINFORCING STEEL SHALL CONFORM TO ASTM A615 OR ASTM A706 (A706 REQUIRED FOR ALL REINFORCING TO BE WELDED) AND SHALL BE GRADE 60 ( $f_y$  = 60 KSI) DEFORMED BARS U.N.O. REINFORCING IN SLABS ON GRADE MAY BE GRADE 40 ( $f_y$  = 40 KSI) DEFORMED BARS FOR ALL BARS #4 AND SMALLER U.N.O. ON PLANS OR DETAILS.
- WELDED WIRE FABRIC SHALL CONFORM TO THE REQUIREMENTS OF ASTM A185. LAPS IN WELDED WIRE FABRIC SHALL BE MADE SUCH THAT THE OVERLAP MEASURED BETWEEN OUTERMOST CROSS WIRE OF EACH FABRIC SHEET, IS NOT LESS THAN THE SPACING OF CROSS WIRES PLUS 2 INCHES.
- FIBER REINFORCING MAY BE USED WHERE SPECIFICALLY NOTED ON PLANS AND SHALL BE FIBERMESH 650 BY PROPEX CONCRETE SYSTEMS OR TUF-STRAND SF BY EUGLO CHEMICAL COMPANY OR APPROVED EQUAL. FIBERS SHALL COMPLY WITH ASTM C 1116 TYPE III, SECTION 4.1.3, AND SHALL BE MIXED WITH CONCRETE AND PLACED PER MFR. RECOMMENDATIONS AT A MINIMUM OF 3.0 LB/CUBIC YARD U.N.O.
- RECTANGULAR PLATE DOWELS AND SMOOTH ROUND DOWELS USED AT CONTROL AND CONNECTION JOINTS IN SLABS ON GRADE SHALL CONFORM TO ASTM A36. REFER TO TYPICAL CONTROL JOINTS IN SLAB ON GRADE DETAIL FOR SIZE, PLACEMENT, SPACING, ETC. RECTANGULAR PLATE DOWELS SHALL BE BY PNA CONSTRUCTION TECHNOLOGIES (800-542-0214) OR OTHER MFR. APPROVED BY ENGINEER. INSTALL ALL PLATE DOWEL BASKET ASSEMBLIES PER MFR.'S RECOMMENDATIONS.
- LAP SPLICES OF REINFORCING STEEL SHALL CONFORM TO TYPICAL REBAR LAP SCHEDULE U.N.O. NO TACK WELDING OF REINFORCING BARS ALLOWED AT WALLS AND FOOTINGS. PROVIDE BENT CORNER BARS TO MATCH AND LAP WITH HORIZ. BARS AT ALL CORNERS AND INTERSECTIONS U.N.O. VERT. WALL BARS SHALL BE SPLICED AT OR NEAR FLOOR LINES. SPLICE TOP BARS AT CENTER LINE OF SPAN AND BOTTOM BARS AT THE SUPPORT IN SPANDRELS, BEAMS, GRADE BEAMS, ETC., U.N.O. ON PLANS OR DETAILS.
- MECHANICAL SPLICE COUPLERS SHALL HAVE CURRENT ICC APPROVAL AND SHALL BE CAPABLE OF DEVELOPING 125% OF THE SPLICED BAR'S YIELD STRENGTH.
- ALL REINFORCING SHALL BE BENT COLD. BARS SHALL NOT BE UN-BENT AND RE-BENT. FIELD BENDING OF REBAR SHALL NOT BE ALLOWED UNLESS SPECIFICALLY NOTED.
- REINFORCING BAR SPLICES SHOWN ON PLANS ARE MAX. ON CENTER DIMENSIONS. DOWEL ALL VERT. REINFORCING TO FOUNDATION. SECURELY TIE ALL BARS IN LOCATION BEFORE PLACING CONCRETE. MIN. CLEAR SPACING BETWEEN PARALLEL REINFORCEMENT SHALL BE THE LARGER OF 1-1/2 TIMES NOMINAL BAR DIA. OR 1-1/3 TIMES MAX. AGGREGATE SIZE OR 1-1/2". CLEAR SPACING LIMITATION APPLIES ALSO TO CLEAR DISTANCE BETWEEN A CONTACT LAP SPLICE AND ADJACENT SPLICES OR BARS.

## REINFORCING STEEL COVER REQUIREMENTS

EXPOSURE CONDITION	COVER
CAST AGAINST AND PERMANENTLY EXPOSED TO EARTH	3"
EXPOSED TO EARTH OR WEATHER	NO. 5 BARS AND SMALLER 1 1/2" NO. 6 BARS AND LARGER 2"
NOT EXPOSED TO WEATHER OR IN CONTACT WITH GROUND	STRUCTURAL SLABS, WALLS, JOISTS NO. 11 BARS AND SMALLER 3/4" NO. 14 BARS AND LARGER 1 1/2" BEAMS AND COLUMNS 1 1/2"

BAR SIZE	CONCRETE			
	MINIMUM CLEAR COVER (INCHES)	MINIMUM CLEAR SPACING (INCHES)	TOP BAR LAP LENGTH (INCHES)	OTHER BARS LAP LENGTH (INCHES)
#3	3/4	1 1/2	19	16
#4	1	2	25	19
#5	1 1/4	2 1/2	31	24
#6	1 1/2	3	37	29
#7	1 3/4	3 1/2	54	41
#8	2	4	61	47
#9	2 1/2	4 3/4	69	53

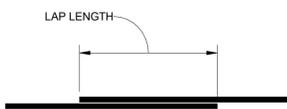

① REINFORCEMENT LAP LENGTHS  
1 1/2" = 1'-0"

# STRUCTURAL QUALITY ASSURANCE


## TEST OF SOILS

	CONTINUOUS SPECIAL INSPECTION	PERIODIC INSPECTION
1. VERIFY MATERIALS BELOW SHALLOW FOUNDATIONS ARE ADEQUATE TO ACHIEVE THE DESIGN BEARING CAPACITY		X
2. VERIFY EXCAVATIONS ARE EXTENDED TO PROPER DEPTH AND HAVE REACHED PROPER MATERIAL		X
3. PERFORM CLASSIFICATION AND TESTING OF COMPACTED FILL MATERIALS		X
4. VERIFY USE OF PROPER MATERIALS, DENSITIES AND LIFT THICKNESS DURING PLACEMENT AND COMPACTION OF COMPACTED FILL.	X	
5. PRIOR TO PLACEMENT OF COMPACTED FILL, INSPECT SUBGRADE AND VERIFY THAT SITE HAS BEEN PREPARED PROPERLY.		X

## CONCRETE CONSTRUCTION

	CONTINUOUS SPECIAL INSPECTION	PERIODIC INSPECTION
1. INSPECT REINFORCEMENT, INCLUDING PRESTRESSING TENDONS, AND VERIFY PLACEMENT.		X
2. INSPECT ANCHORS CAST IN CONCRETE.		X
3. INSPECT ANCHORS POST-INSTALLED IN HARDENED CONCRETE MEMEBERS.		X
A. ADHESIVE ANCHORS INSTALLED IN HORIZONTALLY OR UPWARDLY INCLINED ORIENTATIONS TO RESIST SUSTAINED TENSION LOADS.	N/A	
B. MECHANICAL ANCHORS AND ADHESIVE ANCHORS NOT DEFINED ABOVE.		X
4. VERIFY USE OF REQUIRED DESIGN MIX.		X
5. PRIOR TO CONCRETE PLACEMENT, FABRICATE SPECIMENS FOR STRENGTH TESTS, PERFORM SLUMP AND AIR CONTENT TESTS, AND DETERMINE THE TEMPERATURE OF THE CONCRETE.		X
6. INSPECT CONCRETE PLACEMENT FOR PROPER APPLICATION TECHNIQUES		X
7. VERIFY MAINTENANCE OF SPECIFIED CURING TEMPERATURE AND TECHNIQUES		X
8. INSPECT FORMWORK FOR SHAPE, LOCATION AND DIMENSIONS OF THE CONCRETE MEMBER BEING FORMED.		X

\* REFERENCE IBC TABLE 1705.3 FOR ACI STANDARDS

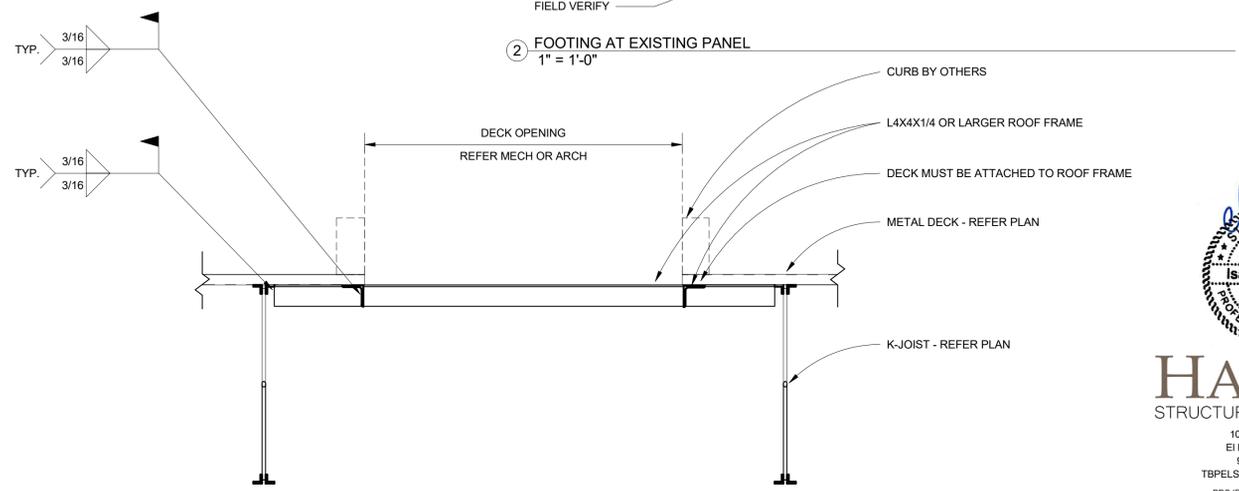

② FOOTING AT EXISTING PANEL  
1" = 1'-0"

③ TYPICAL ROOF FRAME AT JOISTS  
1" = 1'-0"

## SUBMITTALS

- SHOP DRAWINGS OR REPORTS FOR THE FOLLOWING ITEMS SHALL BE SUBMITTED TO THE STRUCTURAL ENGINEER OF RECORD PRIOR TO FABRICATION OR CONSTRUCTION:
  - CONCRETE MIX DESIGN
  - CONCRETE REINFORCEMENT LAYOUT
  - STRUCTURAL STEEL JOIST REINFORCEMENT
  - STRUCTURAL STEEL FRAMING
  - POST INSTALLED ANCHORS
- CONTRACTOR SHALL REVIEW AND STAMP SHOP DRAWINGS PRIOR TO SUBMITTING. CONTRACTOR'S REVIEW SHALL CHECK FOR COMPLETENESS/COMPLIANCE WITH CONTRACT DOCUMENTS.
- SHOP DRAWINGS ARE REVIEWED BY THE ENGINEER ONLY FOR GENERAL COMPLIANCE WITH THE STRUCTURAL DRAWINGS. RESPONSIBILITY FOR CORRECTNESS SHALL REST WITH THE CONTRACTOR. SHOP DRAWINGS DO NOT SUPERSEDE OR REPLACE THE CONTRACT DRAWINGS OR SPECIFICATIONS. CHANGES, SUBSTITUTIONS, OR DEVIATIONS FROM CONTRACT DRAWINGS AND/OR SPECIFICATIONS WILL NOT BE ACCEPTED VIA SHOP DRAWING REVIEW. ALL SUCH MODIFICATIONS SHALL BE SUBMITTED SEPARATELY FOR ENGINEER'S REVIEW.
- DEFERRED SUBMITTALS SHALL INCLUDE CALCULATIONS AND DRAWINGS PREPARED AND STAMPED BY AN APPROPRIATELY LICENSED ENGINEER (SPECIALTY ENGINEER) SHOWING LOCATION AND MAGNITUDE OF LOADS, CONFIGURATION AND SIZE OF MEMBERS, AND COMPATIBILITY OF SUBMITTAL ITEM WITH THE PRIMARY STRUCTURAL SYSTEM.
- THE PURPOSE OF THE ENGINEER'S REVIEW OF DEFERRED SUBMITTALS SHALL BE LIMITED TO DETERMINING THAT THE DRAWINGS AND CALCULATIONS HAVE BEEN PROPERLY SEALED. THAT THE LOAD CRITERIA IS IN GENERAL CONFORMANCE WITH THE CONTRACT DOCUMENTS AND WITH THE REFERENCED BUILDING CODE. THAT CONNECTIONS TO THE PRIMARY STRUCTURE ARE COMPATIBLE WITH THE PRIMARY DESIGN, AND THAT THE PRIMARY STRUCTURE IS CAPABLE OF SUPPORTING THE IMPOSED LOADS.
- ENGINEER WILL RELY UPON THE SPECIALTY ENGINEER'S SEAL AS CERTIFICATION THAT THE ITEMS DESIGNED BY THE SPECIALTY ENGINEER COMPLY WITH THE CRITERIA SET FORTH IN THE CONTRACT DOCUMENTS AND APPLICABLE CODES AND STANDARDS. THE STRUCTURAL ENGINEER SHALL NOT BE RESPONSIBLE FOR THE ADEQUACY OF DESIGNS PROVIDED BY OTHERS.
- FOR ALL SUBMITTALS, ANY CORRECTIONS NOTED WILL BE MARKED ON ONE (1) COPY SET ONLY AND RETURNED. ADDITIONAL COPIES OF ANY SUBMITTAL WILL BE RETURNED UNMARKED. CONTRACTOR SHALL BE RESPONSIBLE FOR REPRODUCING ENGINEER'S CORRECTIONS ON ADDITIONAL COPIES REQ'D. ONE COPY SET MAY BE RETAINED FOR THE ENGINEER'S RECORDS. ALLOW FIVE (5) TO TEN (10) WORKING DAYS FOR THE ENGINEER'S REVIEW.
- REFER TO APPLICABLE GENERAL STRUCTURAL NOTES SECTIONS FOR FURTHER REQUIREMENTS SPECIFIC TO INDIVIDUAL SUBMITTALS.



10/26/2022  
**HARDER**  
STRUCTURAL ENGINEERING  
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El Paso, TX 79901  
915 787 0622  
TBPELS Firm Number: 22328  
PROJECT NUMBER:2022-16

100% CONSTRUCTION DOCUMENTS

**\$100**

**Countryman & Co.**  
Architecture

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PROJECT NO: 2022-16  
ISSUED: OCTOBER 26, 2022

REVISION SCHEDULE:

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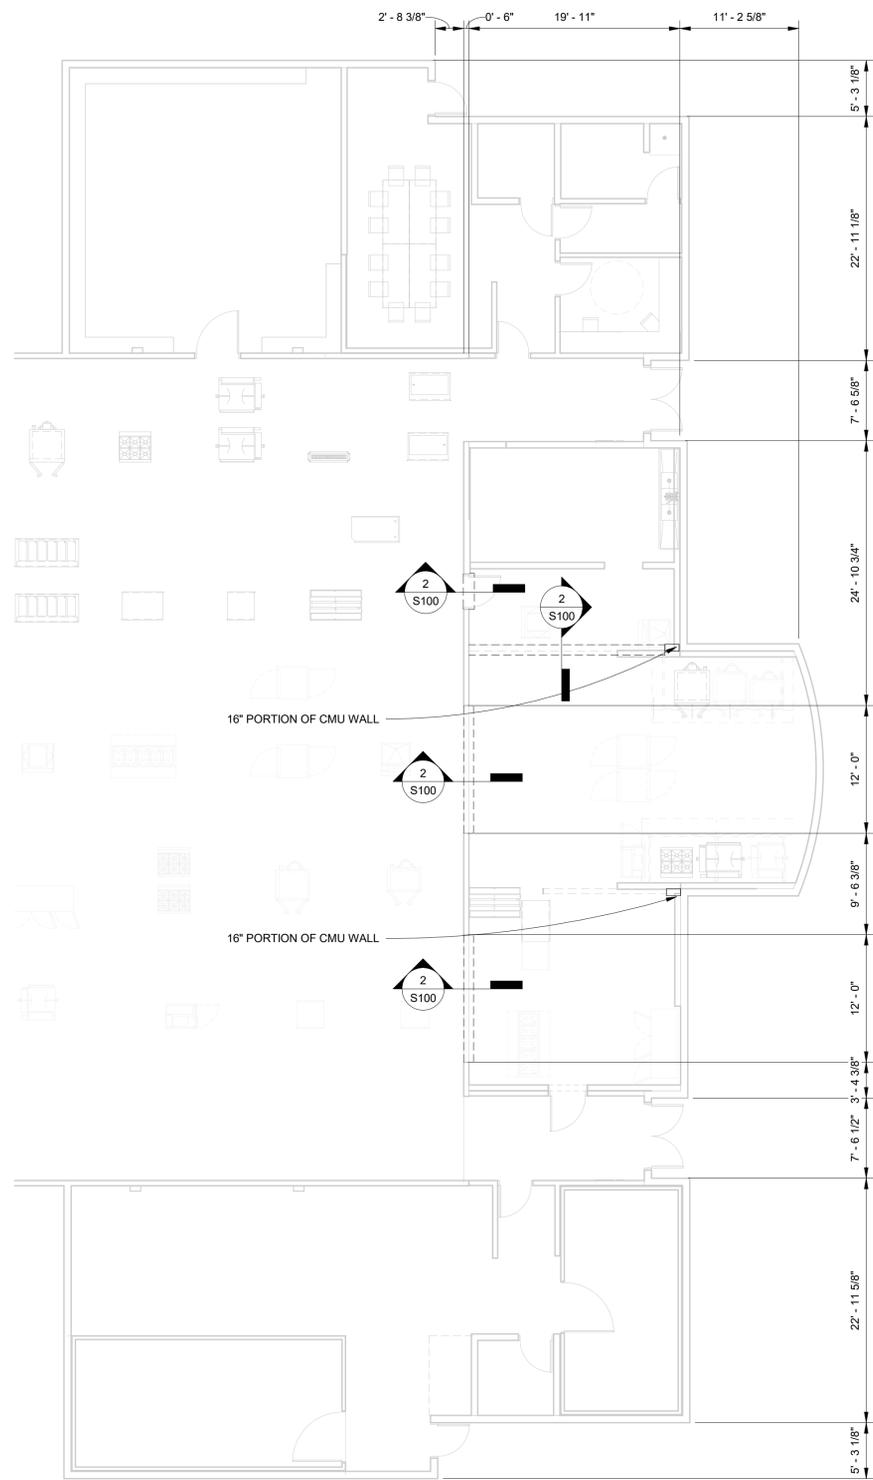
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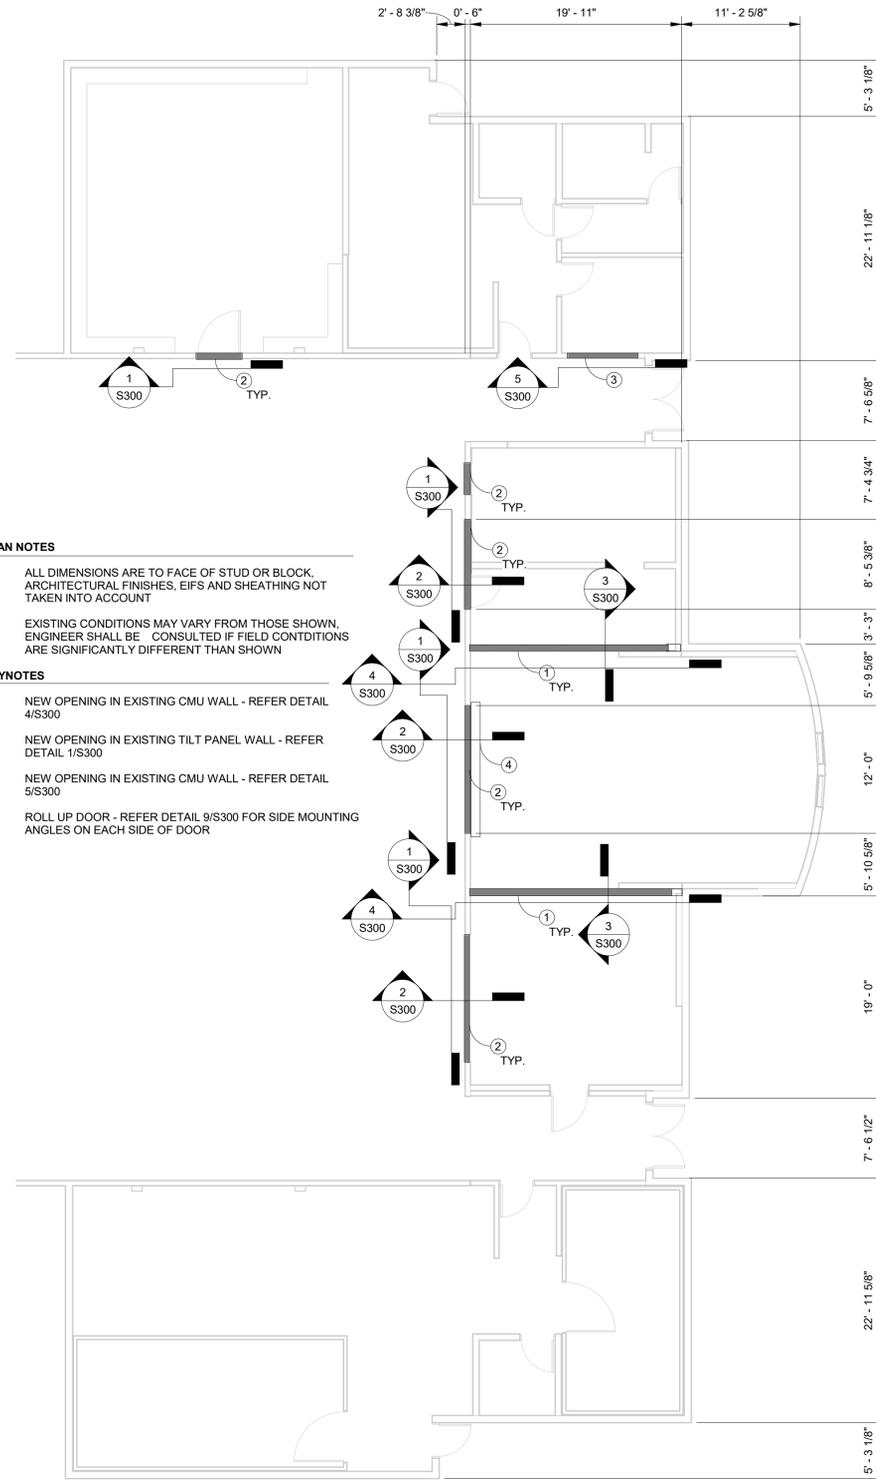
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SHEET TITLE:

**STRUCTURAL NOTES**



① FOUNDATION PLAN  
1/8" = 1'-0"



**PLAN NOTES**


ALL DIMENSIONS ARE TO FACE OF STUD OR BLOCK, ARCHITECTURAL FINISHES, EIFS AND SHEATHING NOT TAKEN INTO ACCOUNT

EXISTING CONDITIONS MAY VARY FROM THOSE SHOWN, ENGINEER SHALL BE CONSULTED IF FIELD CONDITIONS ARE SIGNIFICANTLY DIFFERENT THAN SHOWN

**KEYNOTES**

1. NEW OPENING IN EXISTING CMU WALL - REFER DETAIL 4/S300
2. NEW OPENING IN EXISTING TILT PANEL WALL - REFER DETAIL 1/S300
3. NEW OPENING IN EXISTING CMU WALL - REFER DETAIL 5/S300
4. ROLL UP DOOR - REFER DETAIL 9/S300 FOR SIDE MOUNTING ANGLES ON EACH SIDE OF DOOR

② WALL OPENING PLAN  
1/8" = 1'-0"

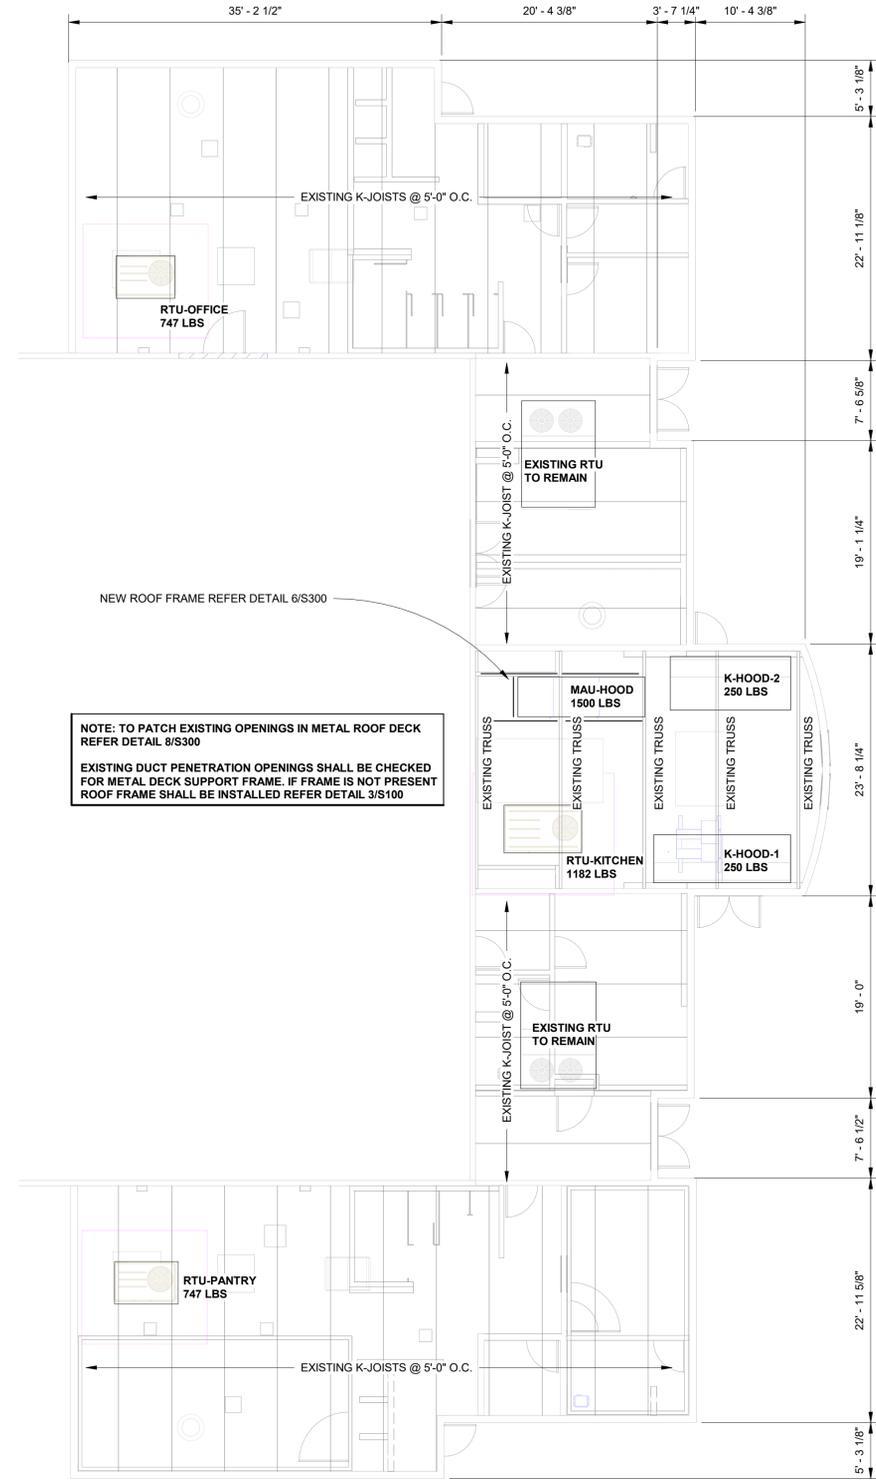

③ ROOF FRAMING  
1/8" = 1'-0"



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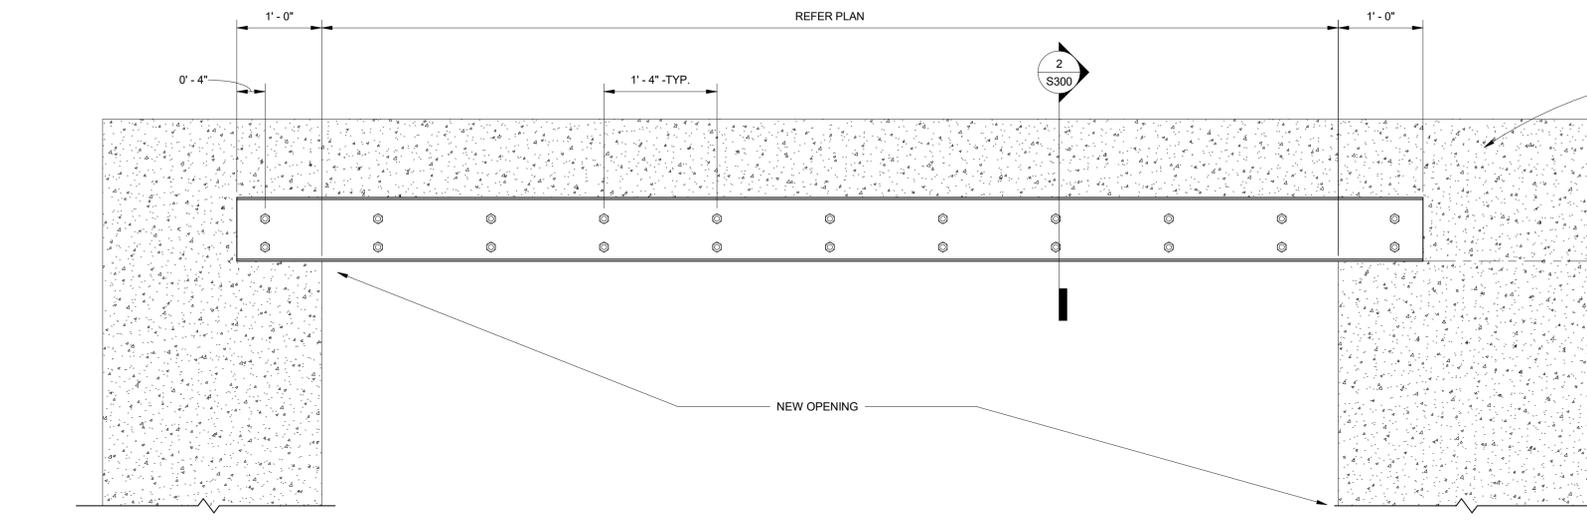
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ISSUED: OCTOBER 26, 2022

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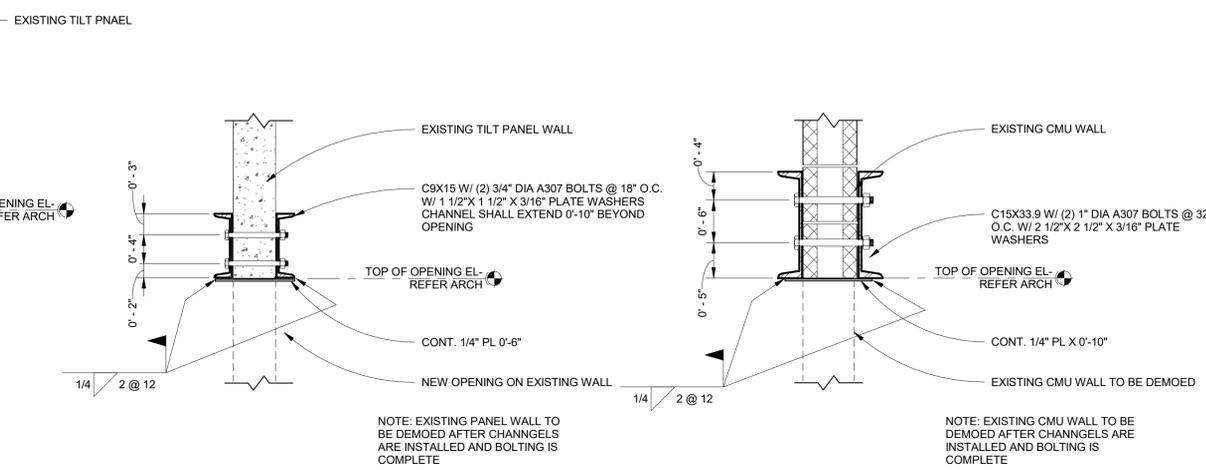
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SHEET TITLE:  
**PLAN VIEW**




1 NEW OPENING IN TILT PANEL ELEVATION 1" = 1'-0"




2 NEW OPENING IN TILT PANEL 1" = 1'-0"


3 NEW OPENING IN CMU 1" = 1'-0"

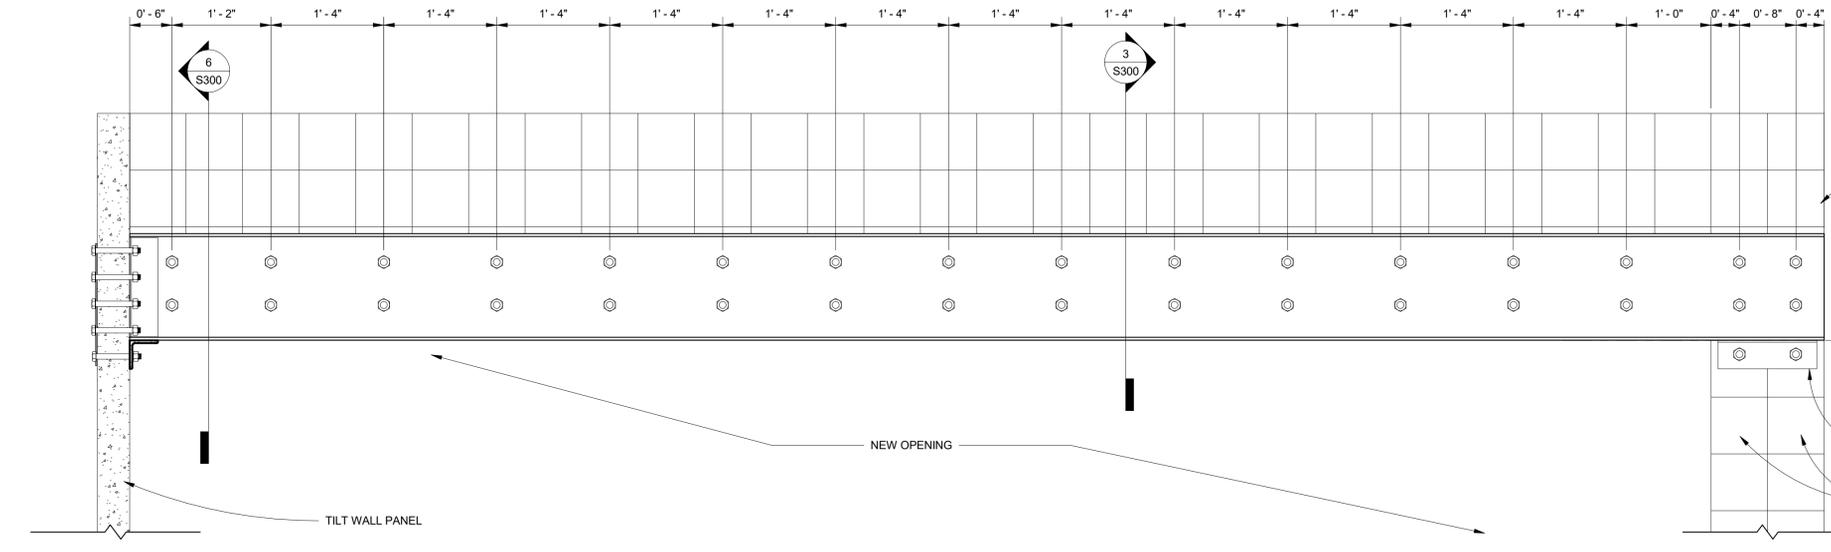


4 NEW OPENING IN CMU WALL ELEVATION 1" = 1'-0"

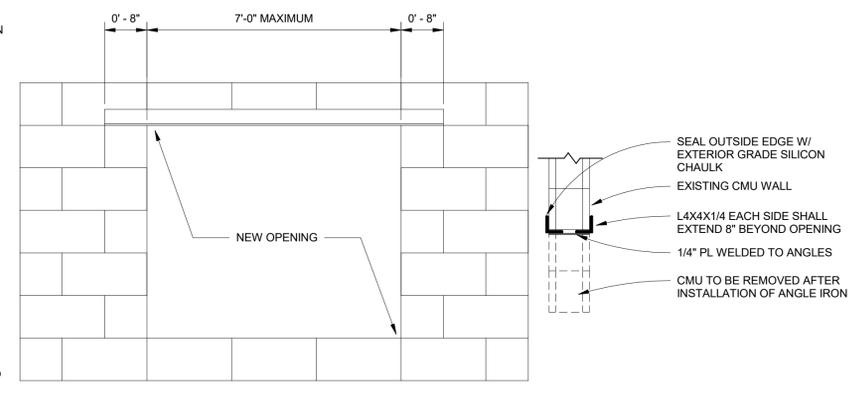


5 NEW OPENING IN CMU 7FT MAX 3/4\"/>

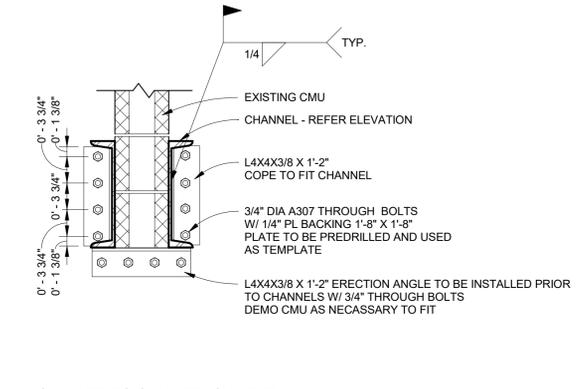


6 CHANNEL TO CMU ATTACHMENT 1" = 1'-0"

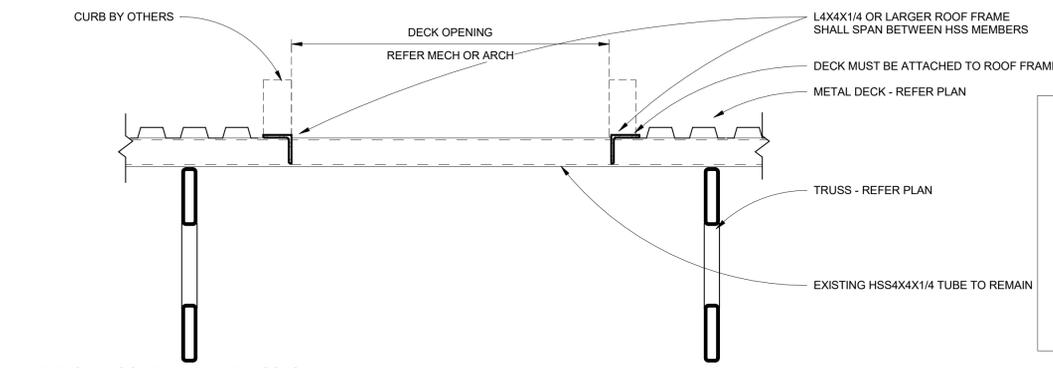

7 TYPICAL ROOF FRAME AT TRUSSES 1" = 1'-0"

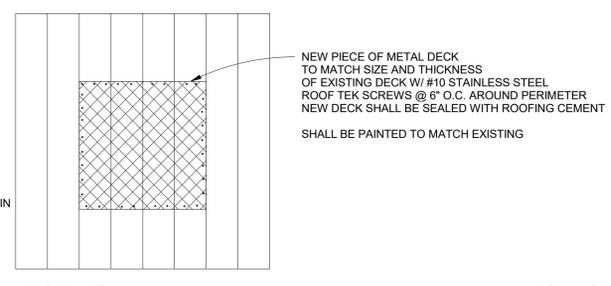

8 DECK PATCH 3/4\"/>

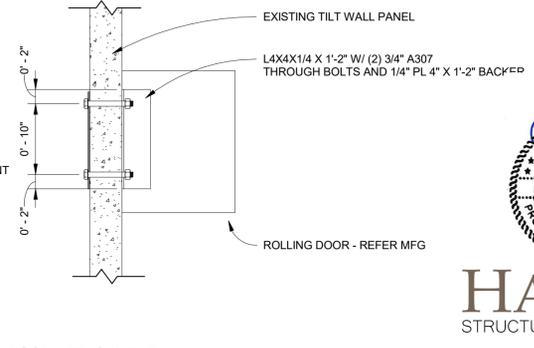

9 ROLLING DOOR ATTACHMENT 1" = 1'-0"



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SHEET TITLE:  
**DETAILS**

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**S300**

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# HVAC GENERAL NOTES

- CONTRACTOR SHALL CAREFULLY REVIEW THESE PLANS, AS WELL AS OTHER RELATED TRADES (INCLUDING ARCHITECTURAL, CIVIL, STRUCTURAL, AND ELECTRICAL) PRIOR TO BID TO INSURE ACCURATE UNDERSTANDING OF EXACT SCOPE OF WORK. ANY ITEMS REQUIRING CLARIFICATION SHALL BE BROUGHT TO THE ATTENTION OF THE ARCHITECT/ENGINEER IN SUFFICIENT TIME TO BE INCORPORATED INTO THE BID.
- CONTRACTOR SHALL VERIFY ALL EQUIPMENT MODEL NUMBERS, CAPACITIES, SIZES, VOLTAGES AND ALL OTHER SCHEDULED INFORMATION WITH ALL OTHER APPLICABLE TRADES AND WITH THE MANUFACTURERS PRIOR TO INSTALLATION.
- THESE DRAWINGS ARE ESSENTIALLY DIAGRAMMATIC AND ARE NOT INTENDED TO INDICATE ALL NECESSARY OFFSETS OF DUCTWORK AND PIPING. THE CONTRACTOR SHALL INSTALL MATERIAL AND EQUIPMENT IN SUCH A WAY AS TO CONFORM TO THE SPACE AVAILABLE, AVOID OBSTRUCTIONS, PRESERVE HEADROOM, AND KEEP OPENINGS AND PASSAGEWAYS CLEAR. ALL INSTALLATIONS SHALL BE CONSISTENT WITH NORMALLY ACCEPTABLE INDUSTRY STANDARDS. THE CONTRACTOR SHALL NOTIFY THE ARCHITECT IN WRITING OF ANY DISCREPANCIES OR CONFLICTS THAT COSTS. THIS NOTIFICATION SHALL BE MADE PRIOR TO THE INSTALLATION OF THE ITEMS CONCERNED.
- NEW AND/OR EXISTING EQUIPMENT INDICATED ON THIS DRAWING IS SHOWN IN APPROXIMATE POSITION(S). CONTRACTOR SHALL FIELD VERIFY ALL EXISTING CONDITIONS INCLUDING EQUIPMENT LOCATIONS, P.O.C.'S AND STRUCTURAL MEMBERS PRIOR TO INSTALLATION. IN ALL CASES, ADEQUATE ACCESS (PER MANUFACTURERS RECOMMENDATIONS AND CODE COMPLIANCE) FOR MAINTENANCE AND REPLACEMENT OF EQUIPMENT SHALL BE PROVIDED.
- ALL WORK SHALL BE DONE IN ACCORDANCE WITH ALL APPLICABLE LOCAL, COUNTY, STATE AND FEDERAL CODES, RULES AND REGULATIONS. NOTHING SHOWN IN THE PLANS IS INTENDED TO INDICATE THAT THE INSTALLATION OR CONNECTIONS OF ANY ITEM OR DEVICE SHOULD BE DONE CONTRARY TO MANUFACTURERS INSTRUCTIONS AND ALL APPLICABLE CODES AND REGULATIONS. THE CONTRACTOR IS RESPONSIBLE TO INSURE THAT THE INSTALLATION AND CONNECTIONS OF ALL ITEMS AND DEVICES CONFORMS TO MANUFACTURERS INSTRUCTIONS AND TO ALL APPLICABLE CODES AND REGULATIONS.
- SUBSTITUTIONS: 10 WORKING DAYS PRIOR APPROVAL REQUIRED AS INDICATED UNDER THE GENERAL AND/OR SUPPLEMENTAL CONDITIONS OF THESE SPECIFICATIONS. MECHANICAL CONTRACTOR SHALL BE RESPONSIBLE FOR ELECTRICAL, MECHANICAL AND CHANGES TO THE STRUCTURE WHEN USING A PRODUCT OTHER THAN THE SPECIFIED PRODUCT. AS BUILT DRAWING CHANGES ARE THE RESPONSIBILITY OF THE MECHANICAL CONTRACTOR.
- PROVIDE LONG RADIUS ELBOWS WITH OUT VANES. MANUAL BALANCING DAMPERS WITH 2" STANDOFF ON ALL BRANCH SUPPLY AND OUTSIDE AIR DUCTS.
- DUCT SIZES SHOWN ARE "CLEAR INSIDE" DIMENSIONS. SNAPLOCK DUCTWORK AND FITTINGS NOT ALLOWED.
- ALL DUCTWORK AND FITTINGS SHALL BE 24 GAUGE MINIMUM. INSTALLED AND FABRICATED IN ACCORDANCE WITH "ASHRAE GUIDELINES AND SMACNA STANDARDS." FOR DUCT SIZE 18" WIDE AND LARGER PROVIDE DUCTMATE 25.
- SEAL ALL DUCT JOINTS WITH A U.L. LISTED HIGH PRESSURE DUCT SEALER DUCTMATE, FIBERSEAL.
- INSULATE ALL SUPPLY AND RETURN DUCTWORK ABOVE THE CEILING WITH R-6 INSTALLED DUCTWRAP. LABEL SUPPLY AND RETURN DUCT SYSTEM WITH THE NAME OF THE AIR CONDITIONING UNIT SOURCE.
- EXACT PLACEMENT OF DIFFUSERS AND REGISTERS SHALL BE COORDINATED WITH ARCHITECTURAL AND ELECTRICAL DRAWINGS PRIOR TO THE INSTALLATION. CONNECT DIFFUSER WITH A 5' SECTION MAXIMUM OF THERMAFLEX COMMERCIAL GRADE MODEL M-KE UL LISTED 181 DUCT WITH 2" INSULATION R-8. RESIDENTIAL FLEXIBLE DUCTWORK NOT ALLOWED.
- ALL HVAC EQUIPMENT, MATERIAL, AND ALL CONNECTIONS THERETO SHALL BE INSTALLED COMPLETE PER MANUFACTURERS INSTRUCTIONS TO PROVIDE A COMPLETE AND FULLY OPERATIONAL SYSTEM.
- CONTRACTOR AND ARCHITECT TO VERIFY SENSOR LOCATIONS. ALL TEMPERATURE SENSORS TO BE MOUNTED 48" A.F.F. IF DDC BMS SYSTEM IS IN PLACE. CONTRACTOR ADVISED THAT ALL HALLWAYS AND GYM SENSORS (IF APPLICABLE) SHALL BE S.S PLATE FLUSH WITH NO LCD DISPLAY AND WITH A RECESSED OVERRIDE BUTTON.
- ALL SUPPLY AND RETURN DUCTS MUST DROP BETWEEN ROOF JOISTS (VERIFY BEFORE SETTING UNITS).
- ALL MECHANICAL WORK MUST BE COORDINATED WITH ARCHITECT AND ELECTRICIAN BEFORE INSTALLATION.
- KEEP ALL FLUES AND EXHAUST CAPS A MINIMUM OF 10' AWAY OR 3' ABOVE ALL FRESH AIR INTAKES ON A/C UNITS AND ALL VERTICAL PORTIONS OF BUILDING OR PLUMBING VENTS PER INTERNATIONAL MECHANICAL CODE.
- CONTRACTOR TO PROVIDE AND INSTALL ALL ROOF TOP UNITS ON A MICROMETL (OR EQUAL) 14" KNOCKDOWN ADJUSTABLE PITCH FACTORY ROOF CURB. INSULATE CURB PERIMETER WALLS IN THE FIELD WITH 1" RIGID INSULATION.
- MECHANICAL CONTRACTOR TO INSTALL NEW FILTERS IN ALL A/C UNITS AT TURN OVER.
- ALL METAL FLUES AND/OR CHIMNEYS FROM FOSSIL FUEL FIRED EQUIPMENT MOUNTED INSIDE THE BUILDING SHALL BE OF DOUBLE WALL CONSTRUCTION TYPE B. TERMINATE WITH HIGH WIND A.G.A VENT CAPS.
- SIZE PROPANE ORIFICES FOR 4000' ELEVATION.
- ALL A/C UNITS SHALL BE INSTALLED WITH A 2" COMMERCIAL GRADE DUCTMATE-PROFLEX DUCT FLEX CONNECTOR.
- PROVIDE BACK DRAFT DAMPERS AND BIRD SCREENS IN ALL EXHAUST SYSTEMS.
- MECHANICAL CONTRACTOR SHALL PROVIDE FIRE DAMPERS WHERE REQUIRED BY CODE AND AT DUCTS PENETRATING RATED ASSEMBLIES. MECHANICAL CONTRACTOR SHALL INSTALL DAMPERS IN ACCORDANCE WITH THE MANUFACTURER'S INSTALLATION INSTRUCTIONS. PROVIDE EACH DAMPER WITH AN 18"x18" DUCTMATE SANDWICH ACCESS DOOR.
- ILLUSTRATIONS SHOWN ARE MEANT TO BE USED AS A GENERAL GUIDE ONLY AND ARE NOT INTENDED TO INCLUDE ALL DETAILS FOR ANY SPECIFIC INSTALLATION. ALL INSTALLATIONS MUST COMPLY WITH ALL APPLICABLE CODES AND ITS CONTRACTORS RESPONSIBILITY TO PROVIDE THE OWNER WITH A FULLY FUNCTIONAL HVAC SYSTEM.
- SENSORS SHALL BE CALIBRATED DURING TEST AND BALANCE AND SHALL BE DOCUMENTED IN THE REPORT.
- CONTRACTOR SHALL PROVIDE A 24X24" GASKETED AIR TIGHT CEILING ACCESS DOORS FOR FIRE DAMPERS, VAV BOXES, FAN COILS. LOCATED ABOVE HARD CEILINGS AND 12X12" ACCESS DOOR FOR PLUMBING ACCESSORIES AND VOLUME DAMPERS.

- CONTRACTOR SHALL PATCH AND PAINT TO MATCH EXISTING CEILINGS, WALLS AND FLOORS THAT WERE OPENED AS PART OF THIS WORK. CONTRACTOR SHALL PROVIDE A PRELIMINARY TAB REPORT THAT SHALL BE REVIEWED BY THE ENGINEER, BEFORE OF SUBSTANTIAL COMPLETION FOR THE PROJECT.
- START UP OF MAJOR EQUIPMENT SHALL BE PROVIDED BY A FACTORY AUTHORIZED AGENT. FIELD REPORTS AND STAR UP CHECK LIST SHALL BE SUBMITTED TO OWNER BY THE START UP AGENT THROUGH THE ENGINEERS PRIOR TO WALK THRU AS A PART OF THE EQUIPMENT CHECK LIST PROCEDURE.
- WARRANTIES CANNOT BEGIN UNTIL THE DATE OF FINAL ACCEPTANCE HAS BEEN ESTABLISHED.
- GENERAL CONTRACTOR SHALL ENGAGE AN NEEB, AABC OR TABB CERTIFIED TEST AND BALANCE COMPANY. PROVIDE A PRELIMINARY TAB REPORT THAT SHALL BE REVIEWED BY THE ENGINEER, OWNER AND ARCHITECT BEFORE PROJECT SUBSTANTIAL COMPLETION.

MECHANICAL SYMBOL LEGEND			
SYMBOL	DESCRIPTION	SYMBOL	DESCRIPTION
	ROOF MOUNTED AIR CONDITIONING UNIT.		FLEXIBLE DUCTWORK.
	SINGLE INLET EVAPORATIVE COOLER.		SUPPLY RIGID DUCTWORK.
	DOUBLE INLET EVAPORATIVE COOLER.		RETURN RIGID DUCT TRANSITION.
	CEILING EXHAUST FAN.		SUPPLY AIR DUCT ROOF PENETRATION
	ROOF MOUNTED EXHAUST FAN.		RETURN DUCT ROOF PENETRATION.
	DIRECT DRIVE IN-LINE EXHAUST FAN.		EXHAUST RIGID DUCT DOWN.
	BELT DRIVEN IN-LINE EXHAUST FAN.		EXHAUST DUCT ROOF PENETRATION
	LOW PROFILE DIRECT DRIVE FAN COIL UNIT.		SIDEWALL SUPPLY AIR OUTLET
	ROOF MOUNTED MAKE-UP AIR UNIT.		SIDEWALL RETURN OR EXHAUST AIR OUTLET
	VOLUME DAMPER.		CEILING DIFFUSER WITH FLEXIBLE DUCT
	SMOKE DAMPER.		HARD CONNECTED CEILING DIFFUSER
	ACCESS DOOR.		CEILING RETURN OR EXHAUST GRILLE.
	NEW TO EXISTING CONNECTION		LONG RADIUS ELBOW WITH OUT VANES.
	EQUIPMENT DESIGNATION		DRAIN LINE
	THERMOSTAT.		CONDENSATE DRAIN
	HUMIDISTAT.		REFRIGERANT LIQUID LINE
	ROOM TEMPERATURE SENSOR.		REFRIGERANT SUCTION LINE
	EXHAUST FAN CONTROL SWITCH.		CHILLED WATER SUPPLY LINE
			CHILLED WATER RETURN LINE
			HOT WATER SUPPLY LINE
			HOT WATER RETURN LINE
			CONDENSER WATER SUPPLY LINE
			CONDENSER WATER RETURN LINE

DIFFUSER AND GRILLE SCHEDULE							
MARK	DESCRIPTION	MANUFACTURER AND MODEL NO.	THROW PATTERN	FACE MODULE	MAX NC	MAX SP	REMARKS
A	TWISTER STAMPED CEILING SWIRL DIFFUSER	NAILOR TWR	SWIRL	24X24	20	0.1"	24"x24" STAMPED FACE MODULE. LAY-IN FRAME. ROUND NECK. STEEL CONSTRUCTION. STANDARD WHITE BAKED ENAMEL FINISH. STEEL RADIAL SLIDING BLADE DAMPER WITH SCREWDRIVER ADJUSTMENT. THERMAFLEX FLEXFLOW ELBOW. THERMAFLEX S.S. SNAPLOCK CLAMP.
B	FIXED PERFORATED DOWNBLAST DIFFUSER	NAILOR UNI-PD	4-WAY	24X24	20	0.1"	24"x24" PERFORATED FACE 3/8" HOLE MODULE. LAY-IN FRAME. ROUND NECK. STEEL CONSTRUCTION. STANDARD WHITE BAKED ENAMEL FINISH. STEEL RADIAL SLIDING BLADE DAMPER WITH SCREWDRIVER ADJUSTMENT. THERMAFLEX FLEXFLOW ELBOW. THERMAFLEX S.S. SNAPLOCK CLAMP.
C	LAY-IN RETURN EGGRATE GRILLE	NAILOR 61 EC-0-L-AW-CB	RETURN	24X24	20	0.1"	24"x24" FACE MODULE WITH A LAY-IN FRAME. STEEL CONSTRUCTION. 1/2"x1/2"x1" CORE. STEEL OPPOSED BLADE DAMPER. STANDARD WHITE ENAMEL FINISH.
D	SURFACE MTD. RETURN EGGRATE GRILLE	NAILOR 61 EC 0 24X24 -S-AW-CB	RETURN	24X24	20	0.1"	SURFACE MOUNTED FRAME. STEEL CONSTRUCTION. 1/2"x1/2"x1" CORE. STEEL OPPOSED BLADE DAMPER. STANDARD WHITE ENAMEL FINISH.
E	HEAVY DUTY RETURN GRILLE	NAILOR 5130H-HD	RETURN	SEE PLAN	20	0.1"	1" WIDE FACE BORDER. CONCEALED MOUNTING. ALUMINUM CONSTRUCTION. FIXED FRONT BARS ON 1/2" CENTERS IN 30 DEGREE DEFLECTION. ALUMINUM OPPOSED BLADE DAMPER THROUGH THE FACE OF REGISTER OPERATOR.

# PACKAGED RTU SCHEDULE

Unit Tags		RTU-OFFICE	RTU-PANTRY	RTU-KITCHEN	Unit Tags			
Quantity		1	1	1	Saturated Discharge Temp Circuit 1 (F)	123.48	123.48	125.3
Model Number		YSC036G3	YSC036G3	YSC092H3	Saturated Suction Temp Circuit 1 (F)	44.25	44.25	45.9
Design Airflow (cfm)		1200	1200	2400	Saturated Discharge Temp Circuit 2 (F)			126.48
Design ESP (in H2O)		1	1	1	Saturated Suction Temp Circuit 2 (F)			45.59
Unit function		DX cooling, gas heat	DX cooling, gas heat	DX cooling, gas heat	Heating capacity	Low gas heat	Low gas heat	Low gas heat
Unit efficiency		Standard efficiency	Standard efficiency	Standard efficiency	Input Heating Capacity (MBh)	67.2	67.2	100.8
Tonnage		3 Ton (036)	3 Ton (036)	7.5 Ton Dual compressor	Output Heating Capacity (MBh)	54.43	54.43	81.65
Airflow Application		Downflow	Downflow	Downflow	Output Heating Cap. w/Fan (MBh)	55.98	55.98	84.7
Height (ft)		3.41	3.41	3.91	Heating EAT (F)	64	64	64
Width (ft)		3.69	3.69	4.44	Heating LAT (F)	114.2	114.2	101.8
Length (ft)		5.82	5.82	7.39	Heating Delta T (F)	50.2	50.2	37.8
Max. unit operating weight (lb)		747	747	1182	Heating Type	Gas Heat	Gas Heat	Gas Heat
EER @ AHRI Conditions (EER)		12	12	11.2	Heating Stages	2	2	1
SEER/IEER		14	14	12.7	Voltage	208-230/60/3	208-230/60/3	208-230/60/3
Component SP (in H2O)		0.1	0.1	0.11	Indoor mtr operating power (bhp)	0.51	0.51	0.94
Total Static Pressure (in H2O)		1.1	1.1	1.11	Indoor RPM (rpm)	1061	1061	800
Evaporator rows (Each)		2	2	3	Indoor Motor Power (kW)	0.38	0.38	0.7
Evaporator fin spacing (Per Foot)		192	192	192	Supply Motor Horsepower (hp)	0.75	0.75	1
Evaporator face area (sq ft)		6.98	6.98	12.36	Max Available ESP (in H2O)	1.15	1.15	
Evaporator face velocity (ft/min)		172	172	194	Outdoor Motor Power (kW)			0.66
Cooling Entering DB (F)		80	80	80	Compressor Power (kW)	2.85	2.85	7.74
Cooling Entering WB (F)		62	62	62	System Power (kW)	3.86	3.86	9.09
Ent Air Relative Humidity (%)				38.12	Compressor 1 RLA (A)	10.4	10.4	14.5
Ambient Temp (F)		105	105	105	Compressor 2 RLA (A)	0	0	14
Evap Coil Leaving Air Temp (DB) (F)		52.39	52.39	50.2	Condenser fan FLA (A)	1.1	1.1	3.3
Evap Coil Leaving Air Temp (WB) (F)		52.26	52.26	50.2	MCA (A)	20	20	39
Cooling Leaving Unit DB (F)		55.56	55.56	51.51	MOP (A)	30	30	50
Cooling Leaving Unit WB (F)		53.48	53.48	50.73	Notes	1, 2, 3, 4, 5, 7, 8	1, 2, 3, 4, 5, 7, 8	1, 2, 3, 4, 6, 7, 8
Net Total Capacity (MBh)		29.2	29.2	74.59	1. PROVIDE 14" ADJUSTABLE PITCH FACTORY INSULATED ROOF CURB.			
Net Sensible Capacity (MBh)		29.1	29.1	66.49	2. PROVIDE WITH ELECTROMECHANICAL CONTROLS.			
Net Sensible Heat Ratio (Number)		1	1	0.89	3. PROVIDE DRY-BULB ECONOMIZER WITH POWER EXHAUST.			
Refrig charge (HFC-410A) - ckt 1 (lb)		3.2	3.2	3.8	4. PROGRAMMABLE THERMOSTAT WITH DIGITAL DISPLAY.			
Refrig charge (HFC-410A) - ckt 2 (lb)				3.6	5. PROVIDE WITH MERV 8 FILTER.			

Countryman & Co.  
Architecture

108 SOUTH STANTON . THIRD FLOOR . EL PASO, TEXAS 79901 915.919.1827



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DRAWN BY: AEG  
PROJECT NO: 2022-16  
ISSUED: 10/24/2022

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NO.	DATE	DESCRIPTION

THIS DRAWING IS INCOMPLETE AND NOT TO BE USED FOR CONSTRUCTION UNLESS IT IS STAMPED, SIGNED AND DATED.

TORNILLO INDEPENDENT SCHOOL DISTRICT CAFETERIA CONVERSION  
300 OIL MILL DR. | TORNILLO, TX 79853

SHEET TITLE:

MECHANICAL SCHEDULES, LEGEND GEN. NOTES

Project Status

M-100

Universal Single Width Fan

MARK INFORMATION		FAN INFORMATION						MOTOR INFORMATION					
QTY	MARK	MODEL	VOLUME (CFM)	TOTAL EXTERNAL SP (IN WG)	FAN RPM	OPERATING POWER (HP)	WEIGHT (LB.)	SIZE (HP)	V/C/P	ENCLOSURE	MOTOR RPM	WINDINGS	NEC FLA*
1	EF-KHOOD 1	USF-24	5,215	1.607	978	1.95	486	2	208/60/3	TF	1725	1	7.5

\*NEC FLA - Based on table 430.250 or 430.248 of National Electrical Code 2020. Actual motor FLA may vary for sizing thermal overload, consult factory"

EF-KHOOD 1 : SELECTED OPTIONS AND ACCESSORIES	
Finish - Coated	Coating - Permatecor, Concrete Gray-RAL 7023, Fan and Attached Accessories
Switch - NEMA-3R, Toggle, For Indoor or Outdoor Use, Ship Separate	Direct Mount Isolators, Isolator-Spring, Restrained, 2 Inch, Indoor / Outdoor Use, Base Coating - N/A
Rotation - CW	Bearings - L(10) Life of 80k Hours
Discharge Position - UB	UL/cUL-762 Outdoor - Power Vent. for Restaurant Exhaust Appliances
Polished Steel Shaft	Access Door - Bolted
Equipment Supports (Qty:2), GESI-64-4-G8, No Coating	Drain Connection - 1" Pipe Thread w/Plug
Inlet Connection, Punched with Companion Flange	Outlet Connection, Slip Fit
Weatherhood - Steel	Heat Slinger
Shaft Seal - High Temp	Grease Trap with Absorbent Material, Shipped Loose

FIRE SYSTEM INFORMATION

MARK	MODEL	LOCATION	FLOW POINTS		SUPPLY LINE	DETECTION	MARK(S) PROTECTED BY FIRE SYSTEM
			HOODS	PCU			
KH-FIRE SUP	ANSUL R-102 WET CHEMICAL	CABINET - RIGHT END OF K-HOOD 1	30 UTILIZED 33 AVAILABLE		CONTINUOUS	FUSIBLE LINK	K-HOOD 1 SECTION 1 K-HOOD 1 SECTION 2 K-HOOD-2 SECTION 1

FIRE SYSTEM OPTIONS AND ACCESSORIES

FULL INSTALLATION (INCLUDES PRE-PIPED HOOD(S) WITH DETECTION AND FACTORY COORDINATED INSTALL)  
 CHROME SLEEVES FOR FACTORY PROVIDED APPLIANCES DROPS - INCLUDED  
 METAL BLOW-OFF CAPS - INCLUDED  
 GAS VALVE - INCLUDED - MECHANICAL SHUTOFF VALVE, 2", (ANSUL) - PART# ANSULMECHSHUTOFFVALVE200  
 HOOD SUPPRESSION TANK - INCLUDED - 9 GAL. - [(3) 3.0 TANK(S)]  
 REMOTE PULL STATION - STANDARD - FIELD INSTALLATION AT SINGLE POINT OF EGRESS  
 BILINGUAL EMERGENCY LABEL - QUANTITY 1 - INCULDED - DISTRIBUTOR INSTALLED

Direct Drive Upblast Centrifugal Roof Exhaust Fan

MARK INFORMATION		FAN INFORMATION						MOTOR INFORMATION					
QTY	MARK	MODEL	VOLUME (CFM)	TOTAL EXTERNAL SP (IN WG)	FAN RPM	OPERATING POWER (HP)	WEIGHT (LB.)	SIZE (HP)	V/C/P	ENCLOSURE	MOTOR RPM	WINDINGS	NEC FLA*
1	EF-DISH	CUE-090-VG	600	0.514	1,725	0.1	34	0.167	115/60/1	TN	1725	1	4.4

\*NEC FLA - Based on table 430.250 or 430.248 of National Electrical Code 2020. Actual motor FLA may vary for sizing thermal overload, consult factory"

EF-DISH : SELECTED OPTIONS AND ACCESSORIES	
Standard Curb Cap Size - 19 Square	UL/cUL 705 Listed - "Power Ventilators"
Switch, NEMA-1, Toggle, Shipped with Unit	Foam Curb Seal (Factory Applied)
Damper Shipped Loose, BD-100-PB-10X10, Gravity Operated, Not Coated	Composite Wheel Material
Controlled With a Switch	

CONTROL INFORMATION

MARK	ELECTRICAL CONTROL PACKAGE		USER INTERFACE		FANS CONTROLLED											
	MODEL	LOCATION	TYPE	LOCATION	FAN #	TYPE	FAN	FAN MARK	ZONE	CFM	MOTOR HP	MOTOR VOLT	CYCLE	MOTOR PHASE	MOTOR STARTER IN PANEL	VFD IN PANEL
KH-CONTROLS	GKC-CV-S-11-3-1-0	SHIP LOOSE ENCLOSURE	FULL COLOR TOUCHSCREEN	SHIP LOOSE	1	EXHAUST	E1	EF-KHOOD 1	1	5215	2	208	60	3	NO	YES
					2	SUPPLY	S1	MAU-HOOD	1	4694	5	208	60	3	NO	NO

CONTROL FEATURES

HOOD LIGHT CONTROL  
 TEMP SENSORS (FACTORY INSTALLED) - QTY. 3  
 DRY FIRE CONTACTS - QTY. 2  
 LIGHTS OFF DURING FIRE  
 EXHAUST MAX DURING FIRE  
 SUPPLY OFF DURING FIRE  
 HIGH TEMPERATURE ALARM  
 FAN PROVING - SUPPLY ONLY  
 GAS RESET  
 VFD(S) IN CONTROL PANEL PROVIDED FOR BALANCING

HOOD INFORMATION

HOOD NO.	MARK	MODEL	HOOD DIMENSIONS (IN.)			HOOD CONSTR.	COOKING LOAD / DUTY RATING	TOTAL CFM	EXHAUST COLLAR(S)					MUA CFM	AC CFM	TOTAL WEIGHT LBS.	SECTION LOCATION
			LENGTH	WIDTH	HEIGHT				WIDTH	LENGTH	DIA.	CFM	S.P.				
1	K-HOOD 1	GXEW-77-S	77	54	24	4,430 SS WHERE EXPOSED	HEAVY	1589	10	15		1589	0.607	1342		230.82	LEFT
2	K-HOOD 1	GXEW-77-S	77	54	24	4,430 SS WHERE EXPOSED	4;HEAVY	1393	10	13		1393	0.538	1342		4;227.67	RIGHT

HOOD INFORMATION

HOOD NO.	MARK	LIGHTING DETAILS			GREASE FILTRATION DETAILS			UTILITY CABINET(S)				
		FIXTURE TYPE BULB / LAMP INFO	QTY	FOOT CANDLES	TYPE / MODEL MATERIAL	QTY	SIZE (IN.) L H	LOCATION	FIRE SYSTEM TYPE	SIZE	MODEL	CONTROLS INTERFACE
1	K-HOOD 1	INCANDESCENT (GLOBE) 100W A19 (BULBS NOT INCL.)	4	46.91	X-TRACTOR STAINLESS STEEL	1	16 20	LEFT				
2	K-HOOD 1	INCANDESCENT (GLOBE) 100W A19 (BULBS NOT INCL.)	4	46.91	X-TRACTOR STAINLESS STEEL	1	16 20	RIGHT	ANSUL R102	9		

SUPPLY PLENUM INFORMATION

HOOD NO.	MARK	POS.	TYPE	SIZE (IN.)			INSULATED	DAMPER(S)	LED LIGHT(S)		TOTAL CFM	COLLARS						
				L	W	H			SUPPLIED	QTY		TYPE	MOUNTING	QTY	W	L	DIA.	CFM
1	K-HOOD 1	FRONT	ASP	89	18	4	NO	YES	NO	1342	MUA	FACTORY	2	16	30	671	0.15	201
2	K-HOOD 1	FRONT	ASP	89	18	4	NO	YES	NO	1342	MUA	FACTORY	2	16	30	671	0.15	201

HOOD OPTIONS

UL 710 LISTED W/ OUT EXHAUST FIRE DAMPER - UL #MH11726  
 BACK INTEGRAL AIR SPACE - 3 IN WIDE  
 12 IN HIGH CEILING ENCLOSURES - FRONT LEFT RIGHT - FIELD INSTALLED  
 FACTORY MOUNTED EXHAUST COLLAR(S)  
 FILTER REMOVAL TOOL INCLUDED - QTY 1  
 BACKSPLASH 78.00 IN HIGH 178.00 IN LONG  
 PERFORMANCE ENHANCING LIP (PEL) TECHNOLOGY  
 STANDING SEAM CONSTRUCTION FOR SUPERIOR STRENGTH

HOOD INFORMATION

HOOD NO.	MARK	MODEL	HOOD DIMENSIONS (IN.)			HOOD CONSTR.	COOKING LOAD / DUTY RATING	TOTAL CFM	EXHAUST COLLAR(S)					MUA CFM	AC CFM	TOTAL WEIGHT LBS.	SECTION LOCATION
			LENGTH	WIDTH	HEIGHT				WIDTH	LENGTH	DIA.	CFM	S.P.				
1	K-HOOD-2	GXEW-136-S	136	60	24	4,430 SS WHERE EXPOSED	4;HEAVY	2233	10	21		2233	0.483	2010		4;376.499	SINGLE

HOOD INFORMATION

HOOD NO.	MARK	LIGHTING DETAILS			GREASE FILTRATION DETAILS			UTILITY CABINET(S)				
		FIXTURE TYPE BULB / LAMP INFO	QTY	FOOT CANDLES	TYPE / MODEL MATERIAL	QTY	SIZE (IN.) L H	LOCATION	FIRE SYSTEM TYPE	SIZE	MODEL	CONTROLS INTERFACE
1	K-HOOD-2	INCANDESCENT (GLOBE) 100W A19 (BULBS NOT INCL.)	6	50.7	X-TRACTOR STAINLESS STEEL	6	16 20	LEFT RIGHT	ANSUL R102	9		

SUPPLY PLENUM INFORMATION

HOOD NO.	MARK	POS.	TYPE	SIZE (IN.)			INSULATED	DAMPER(S)	LED LIGHT(S)		TOTAL CFM	COLLARS						
				L	W	H			SUPPLIED	QTY		TYPE	MOUNTING	QTY	W	L	DIA.	CFM
1	K-HOOD-2	FRONT	ASP	80	14	4	NO	YES	NO	1005	MUA	FACTORY	2	12	28	503	0.1	216
1	K-HOOD-2	FRONT	ASP	80	14	4	NO	YES	NO	1005	MUA	FACTORY	2	12	28	503	0.1	216

HOOD OPTIONS

UL 710 LISTED W/ OUT EXHAUST FIRE DAMPER - UL #MH11726  
 BACK INTEGRAL AIR SPACE - 3 IN WIDE  
 12 IN HIGH CEILING ENCLOSURES - FRONT LEFT RIGHT - FIELD INSTALLED  
 FACTORY MOUNTED EXHAUST COLLAR(S)  
 FILTER REMOVAL TOOL INCLUDED - QTY 1  
 BACKSPLASH 78.00 IN HIGH 160.00 IN LONG  
 PERFORMANCE ENHANCING LIP (PEL) TECHNOLOGY  
 STANDING SEAM CONSTRUCTION FOR SUPERIOR STRENGTH

Countryman & Co.  
 Architecture

108 SOUTH STANTON . THIRD FLOOR . EL PASO, TEXAS 79901 915.919.1827



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TORNILLO INDEPENDENT SCHOOL  
 DISTRICT CAFETERIA CONVERSION  
 300 OIL MILL DR. | TORNILLO, TX 79853

SHEET TITLE:

MECHANICAL SCHEDULES, LEGEND, GEN. NOTES





Project Status

M-101

EQUIPMENT SCHEDULE										
Tempered Make-Up Air Unit										
Qty	Greenheck Model	Volume	External SP	Total SP	FRPM	Operating Power	Weight			
1	DGX-112-H22	4,700 CFM	0.93 in. wg	2.268 in. wg	1412	3.89 hp	1,555 lb			
<b>Motor Information</b> Mark: MAU-HOOD Size: 5 hp, V/C/P: 208/60/3, Enclosure: ODP, Motor with Shaft Grounding: No, Motor RPM: 1725, Windings: 1, MCA: 22.8, MOP: 35										
Heating										
Type	Gas Type	Temperature			Energy	Connection	Building Gas Pressure	Control Access		
Direct Gas	Natural	Winter DB	Max Δ	Max LAT	Input	Output	Efficiency			
		22.6 F	42.4 F	65.0 F	202.4 MBH	186.2 MBH	92%	3/4"		
Cooling										
Cooling Type	Cooling Media	Summer Bulb		Filters	Cooling Control	Required Flow**				
Evaporative	GLASdek	Dry	Wet							
		100.6 F	70.3 F	2in. Aluminum Mesh	Recirculating Pump	NA				
<small>**Required flow and inlet pressure are for supply line sizing only. They do not represent water usage during normal operation. Consult factory for actual water usage.</small>										
Outlet Sound Power By Octave Band										
62.5	125	250	500	1000	2000	4000	8000	LwA	dBA	Sones
96.9	83.4	83.3	85.3	85.5	83.1	82.7	76.6	90.4	79.4	35.4
<small>LwA - A weighted sound power level based on ANSI S1.4            dBA - A weighted sound pressure level based on 11 ft dB attenuation per octave band at 5.0 ft            Noise Criteria (NC) based on an average attenuation of 11.5 dB per octave band at 5.0 ft.</small>										







**OPTIONS AND ACCESSORIES**

Air Flow Arrangement: Outdoor Air Only  
 Filter Section: MERV8, 20x20x2 - (6)  
 Damper: Inlet  
 Outdoor Air Intake Position: End  
 Discharge Position: End  
 Coating: Galvanized  
 Insulation: Double Wall - Tempering On  
 Supply Fan Control: VFD  
 VFD Control: Constant Volume  
 Hinged Access  
 Access Side: Right-Hand  
 Control Center  
 Freeze Protection  
 Heat Inlet Air Sensor  
 Cool Inlet Air Sensor  
 Dirty Filter Switch  
 Unit Controls: Terminal Strip  
 Temperature Control: Discharge  
 Direct Gas Options/Accessories  
 Approvals: ETL  
 FM Compliant

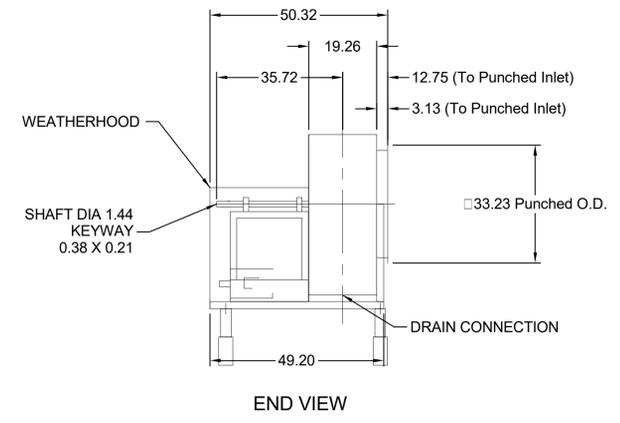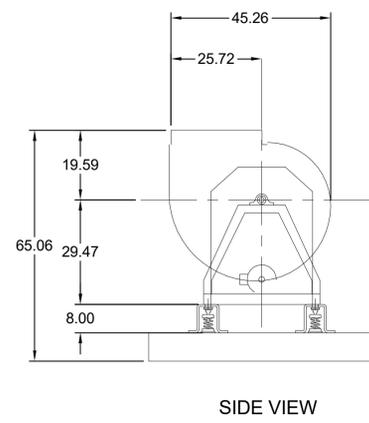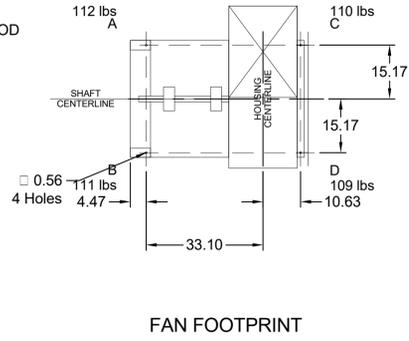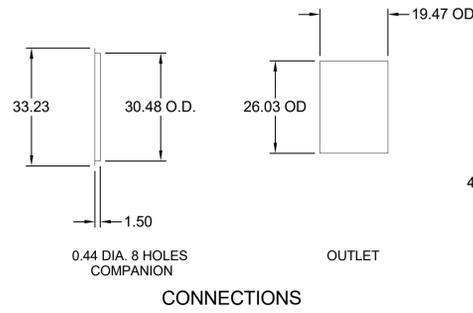

\*SIDE VIEW IS VIEWED FROM DRIVE SIDE  
 \*FANS ARE SUBJECT TO ± 1/16 INCH TOLERANCE  
 \*DUE TO CONTINUAL IMPROVEMENTS DIMENSIONS MAY CHANGE

2 EF-KHOOD1 SCHEMATIC  
 M-102 N.T.S.

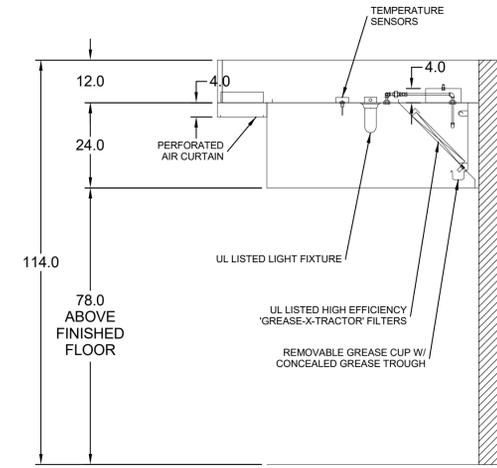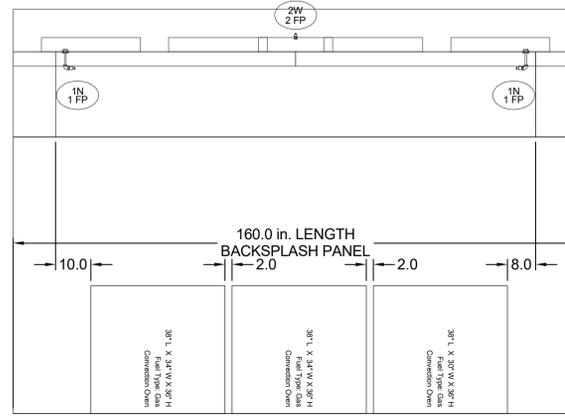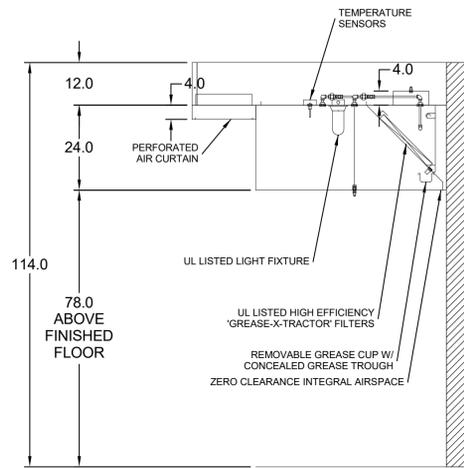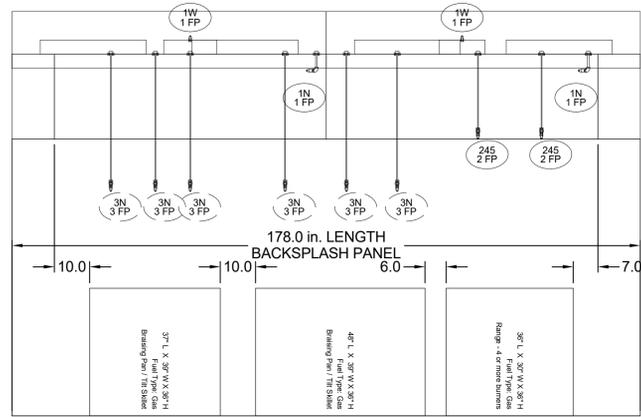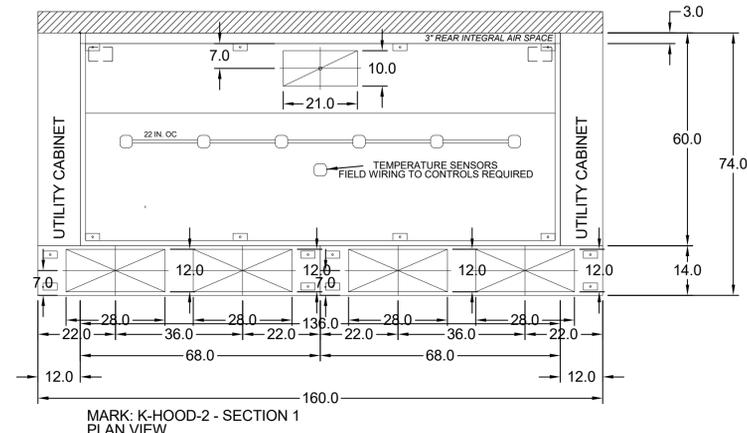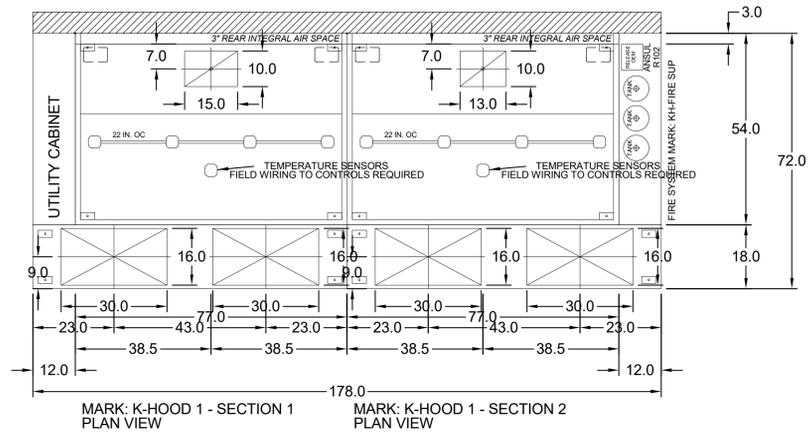

3 K-HOOD 1 & 2 SCHEMATICS  
 M-102 N.T.S.

Countryman & Co.  
 Architecture

108 SOUTH STANTON . THIRD FLOOR . EL PASO, TEXAS 79901 915.919.1827



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DRAWN BY: AEG  
 PROJECT NO: 2022-16  
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NO.	DATE	DESCRIPTION

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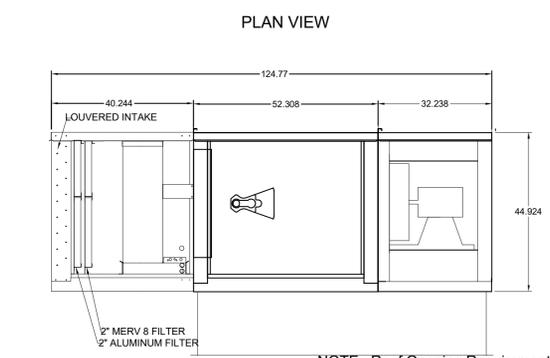
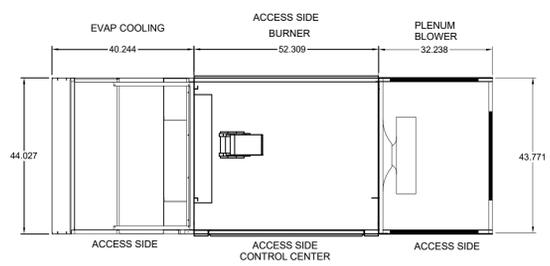
TORNILLO INDEPENDENT SCHOOL  
 DISTRICT CAFETERIA CONVERSION  
 300 OIL MILL DR. | TORNILLO, TX 79853

SHEET TITLE:

MECHANICAL SCHEDULES & SCHEMATICS

Project Status


M-102



**NOTE: Roof Opening Requirements:**  
 Minimum Roof Opening: The minimum roof opening size is the illustrated duct diameter plus 0.25 in. on all sides.  
 For example: If the duct size is 14 x 14 in. square, the minimum roof opening size is 14.5 x 14.5 in. square.

Maximum Roof Opening: There must be a minimum perimeter of 1.75 in. between the roof opening and the roof curb.  
 For example: If the roof curb is 75 x 30 in. square, the maximum roof opening is 71.5 x 26.5 in. inches square.  
**NOTE:** The weatherhood and filter sections of the make-up air unit are not supported by the curb. This is by design, in order to help alleviate water infiltration issues.

### 1 MAU-HOOD SCHEMATICS

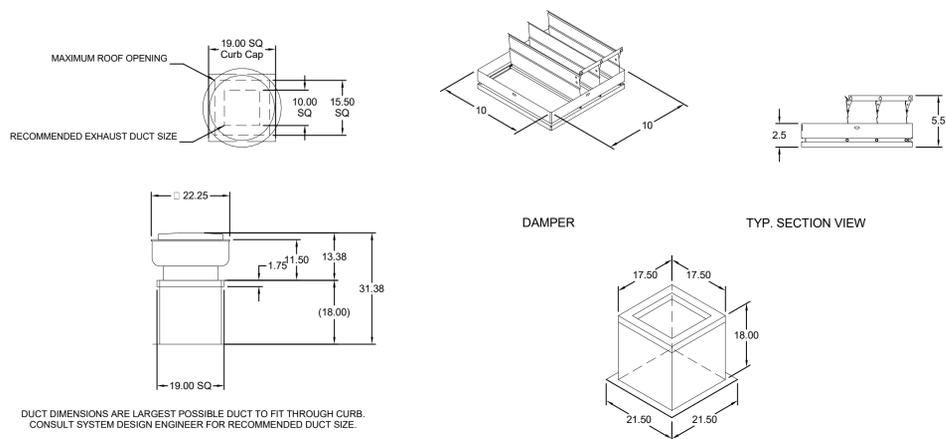


DUCT DIMENSIONS ARE LARGEST POSSIBLE DUCT TO FIT THROUGH CURB. CONSULT SYSTEM DESIGN ENGINEER FOR RECOMMENDED DUCT SIZE.  
 OVERALL HEIGHT MAY BE GREATER DEPENDING ON MOTOR, ADAPTER, AND/OR HINGE BASE.

### 2 DISHWASHER EXHAUST FAN SCHEMATICS



**NOTES:**  
 WET CHEMICAL FIRE PROTECTION SYSTEM TO BE ANSUL R-102, DESIGNED IN COMPLIANCE WITH UL 300 REQUIREMENTS.  
 -VERIFICATION OF ALL COOKING EQUIPMENT MAKE, MODEL AND LOCATION REQUIRED FOR ALL FIRE PROTECTION SYSTEMS.  
 -ALL FIRE SYSTEM PIPING IS STANDARDLY TO THE RIGHT END OF THE HOOD UNLESS A WALL IS LOCATED ON THE RIGHT END.  
 -ANSUL AUTOMAN RELEASE TO BE LOCATED WITHIN 60' OF HOOD.

THE BASIC FIRE SYSTEM WILL INCLUDE THE FOLLOWING:  
 -GAS SHUT-OFF VALVE, IF REQUIRED, TO BE SUPPLIED BY MANUFACTURER (UP TO 2" DIAMETER AS STANDARD), AND INSTALLED BY A LICENSED PLUMBER.  
 -J-MICRO SWITCH TO BE SUPPLIED BY MANUFACTURER FOR CONNECTION TO, BUT NOT LIMITED TO, BUILDING ALARM SYSTEM(S), EXHAUST AND SUPPLY FANS AND ELECTRICAL POWER SHUT DOWN. FIELD WIRING AND CONNECTIONS TO BE PERFORMED BY A LICENSED ELECTRICIAN.  
 -INSTALLATION OF GAS SHUT-OFF VALVE.  
 -SPECIAL DRAWINGS REQUIRED TO SATISFY STATE OR LOCAL CODE. PLAN EXAMINATION FEES, PE OR FS APPROVAL STAMP.  
 -UNION LABOR, GOVERNMENT LABOR, OR PREVAILING WAGES REQUIRED FOR FINAL FIELD HOOKUP.  
 -ANY AND ALL ELECTRICAL COMPONENTS/CONNECTIONS REQUIRED TO SHUT DOWN FANS, SHUT OFF DEVICE FOR ELECTRIC COOKING EQUIPMENT (SHUNT TRIP BREAKER), OR ACTIVATE AN ALARM SYSTEM, ETC.  
 -ANY DISMANTLING OR REASSEMBLY REQUIRED TO GAIN ACCESS TO THE FIRE SUPPRESSION PIPING LOCATED ON THE TOP OF THE HOOD.  
 -ROUGH-IN HIDDEN CONDUIT FOR REMOTE PULL STATION OR GAS VALVE (FLUSH MOUNTED PULL STATION).  
 -INSTALLATION OF MORE THAN (1) REMOTE PULL STATIONS OR DISTANCES GREATER THAN 20 FT (6.1M).  
 -PARTS OR LABOR REQUIRED TO CORRECT PIPING DUE TO COOKING EQUIPMENT CHANGES OR DEVIATION FROM PLANS, OR ANY CHARGES FOR MISSING OR ADDITIONAL PARTS OTHER THAN THOSE INDICATED ON THE FIRE SUPPRESSION DETAIL.

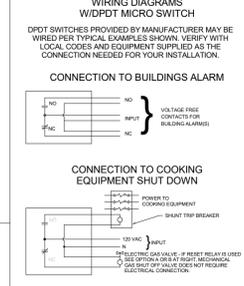

**NOTES:**  
 1. --- DENOTES FIELD INSTALLATION.  
 2. --- DENOTES FACTORY INSTALLATION.  
 3. DO NOT USE BLACK WIRE ON SHUNT-Trip SWITCH IN NORMAL INSTALLATION. BLACK WIRE TO BE USED ONLY FOR EXTRANEOUS ALARM, LIGHT CIRCUITS, ETC.

### 3 KH-FIRE SUP DETAILS

### Trane Precedent Gas/Electric Packaged Rooftop

Unit Overview - YSC036G3											
Application	Unit Size	Supply Fan	External Static Pressure	External Dimensions (in.)			Operating Weight		EER	I EER/SEER	Elevation
DX cooling, gas heat	3 Ton (036)	Airflow 1200 cfm	1,000 in H2O	Height 3.41 ft	Width 3.69 ft	Length 5.82 ft	Minimum 472.0 lb	Maximum 747.0 lb	12.0 EER	14.00	4000.0 ft

Unit Overview - YSC036G3											
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### Trane Precedent Gas/Electric Packaged Rooftop

Unit Overview - YSC02H3											
Application	Unit Size	Supply Fan	External Static Pressure	External Dimensions (in.)			Operating Weight		EER	I EER/SEER	Elevation
DX cooling, gas heat	7.5 Ton Dual compressor	Airflow 2400 cfm	1,000 in H2O	Height 3.91 ft	Width 4.44 ft	Length 7.39 ft	Minimum 847.0 lb	Maximum 1162.0 lb	11.2 EER	12.70	4000.0 ft

Cooling Section		Capacity	
Entering Dry Bulb	80.00 F	Gross Total	77.64 MBh
Entering Wet Bulb	62.00 F	Gross Sensible	69.54 MBh
Ambient Temp	105.00 F	Net Total	74.59 MBh
Leaving Coil Dry Bulb	52.20 F	Net Sensible	66.49 MBh
Leaving Coil Wet Bulb	52.20 F	Fan Motor Heat	3.05 MBh
Leaving Unit Dry Bulb	51.51 F	Refrig Charge-circuit	1.3 lb
Leaving Unit Wet Bulb	50.73 F	Refrig Charge-circuit	2.5 lb

### 4 RTU-KITCHEN SUBMITTAL

### COMcheck Software Version 4.1.5.3 Mechanical Compliance Certificate

**Project Information**  
 Energy Code: 2015 IECC  
 Project Title: TORNILLO INDEPENDENT SCHOOL DISTRICT CAFETERIA CONVERSION  
 Location: El Paso, Texas  
 Climate Zone: 3b  
 Project Type: Alteration

**Mechanical Systems List**  
 1 RTU-OFFICE (Single Zone)  
 Heating: 1 each - Central Furnace, Propane, Capacity = 47 kBtu/h  
 No minimum efficiency requirement applies  
 Cooling: 1 each - Single Package DX Unit, Capacity = 30 kBtu/h, Air-Cooled Condenser, No Economizer, Economizer exception: High Efficiency Equipment  
 Proposed Efficiency = 14.00 SEER, Required Efficiency: 14.00 SEER  
 Fan System: None

1 RTU-PANTRY (Single Zone)  
 Heating: 1 each - Central Furnace, Propane, Capacity = 47 kBtu/h  
 No minimum efficiency requirement applies  
 Cooling: 1 each - Single Package DX Unit, Capacity = 30 kBtu/h, Air-Cooled Condenser, No Economizer, Economizer exception: High Efficiency Equipment  
 Proposed Efficiency = 14.00 SEER, Required Efficiency: 14.00 SEER  
 Fan System: None

1 RTU-KITCHEN (Single Zone)  
 Heating: 1 each - Central Furnace, Propane, Capacity = 69 kBtu/h  
 No minimum efficiency requirement applies  
 Cooling: 1 each - Single Package DX Unit, Capacity = 66 kBtu/h, Air-Cooled Condenser, No Economizer, Economizer exception: High Efficiency Equipment  
 Proposed Efficiency = 12.70 EER, Required Efficiency: 12.65 EER  
 Fan System: None

**Mechanical Compliance Statement**  
 Compliance Statement: The proposed mechanical alteration project represented in this document is consistent with the building plans, specifications, and other calculations submitted with this permit application. The proposed mechanical systems have been designed to meet the 2015 IECC requirements in COMcheck Version 4.1.5.3 and to comply with any applicable mandatory requirements listed in the Inspection Checklist.  
 JORGE A. SILVA - PE  
 Signature: *Jorge A. Silva* Date: 10/25/22

Project Title: TORNILLO INDEPENDENT SCHOOL DISTRICT CAFETERIA CONVERSION Report date: 10/25/22  
 Data filename: P:\2022\2226 Tornillo HS Gym to Kitchen Conversion\_Design\Documents\Comcheck Report\TORNILLO CAFETERIA CONVERSION.cck Page 1 of 10

## Countryman & Co. Architecture

108 SOUTH STANTON . THIRD FLOOR . EL PASO, TEXAS 79901 915.919.1827



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### 5 RTU-OFFICE SUBMITTAL

### 6 RTU-PANTRY SUBMITTAL

### 7 COMCHECK REPORT


# TORNILLO INDEPENDENT SCHOOL DISTRICT CAFETERIA CONVERSION

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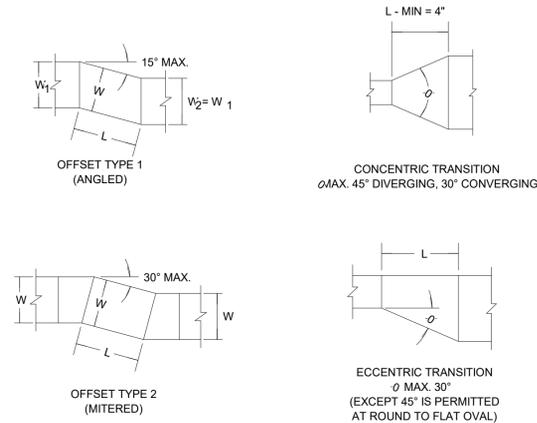
## MECHANICAL SCHEDULES & SCHEMATICS

M-103


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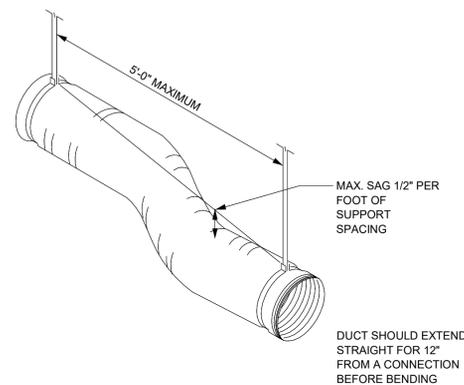
1 **ZERO PRESSURE VENT STACK**  
M-104 / N.T.S.

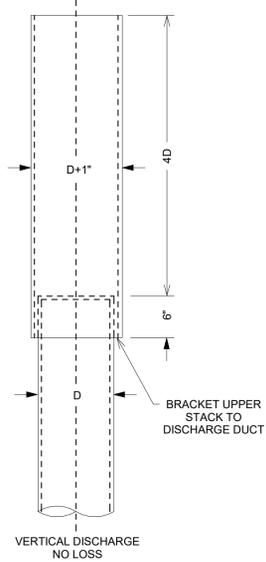


2 **OFFSETS AND TRANSITIONS**  
M-104 / N.T.S.



3 **LOWER HANGER ATTACHMENTS**  
M-104 / N.T.S.

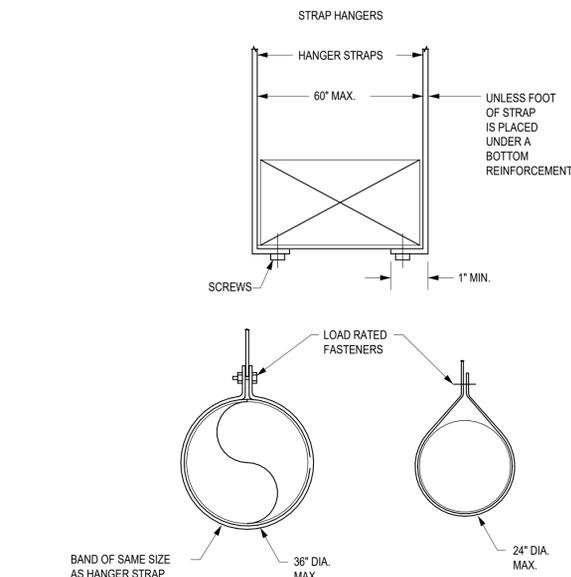


5 **FLEXIBLE DUCT SUPPORT**  
M-104 / N.T.S.

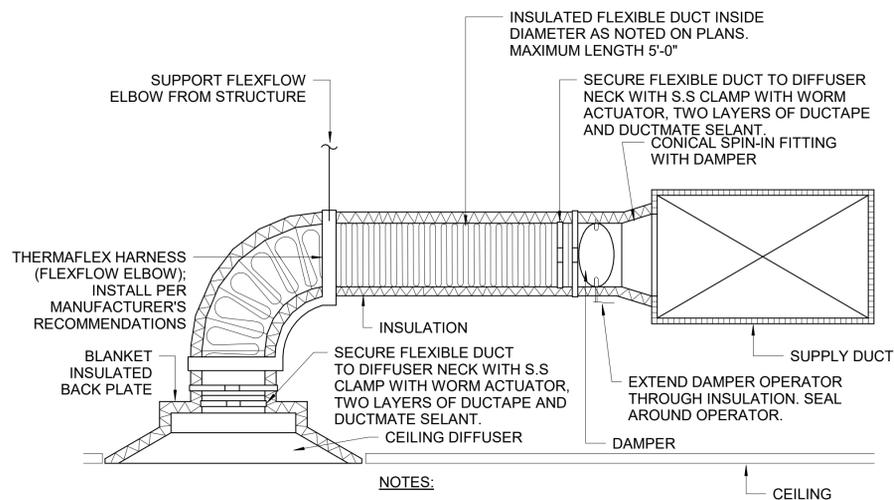


- NOTES:**
1. SEAL ALL JOINTS PER SPECIFICATIONS.
  2. FLEX DUCT SAG LIMITED TO 1/2" PER FOOT.
  3. MAX 30° OFFSET ALLOWED IN FLEX DUCT ROUTING.

4 **CEILING DIFFUSER CONNECTION DETAIL**  
M-104 / N.T.S.

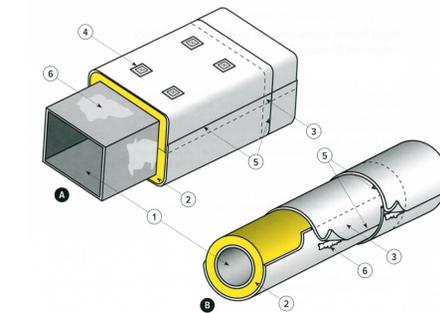

Hot and cold air ducts may be insulated using flexible fibrous blanket insulation. Applications generally require no additional finish beyond the factory-applied vapor-retarder jacket.  
Detail A - Rectangular.  
Detail B - Round or oval.  
Materials: Flexible blanket of glass or mineral fiber insulation, vapor-retarder tape or mastic, adhesive and mechanical fasteners. Follow manufacturers' recommended stretch-out schedule to avoid compression of the insulation to achieve required installed "R-values". (See table below.)  
1. Duct.  
2. Insulation.  
3. Lap.  
4. Mechanical fasteners.  
5. Vapor-retarder tape or mastic.  
6. Adhesive (optional).  
Duct Wrap Stretch-outs:

6 **FLEXIBLE FIBROUS BLANKET DUCT INSULATION**  
M-104 / N.T.S.

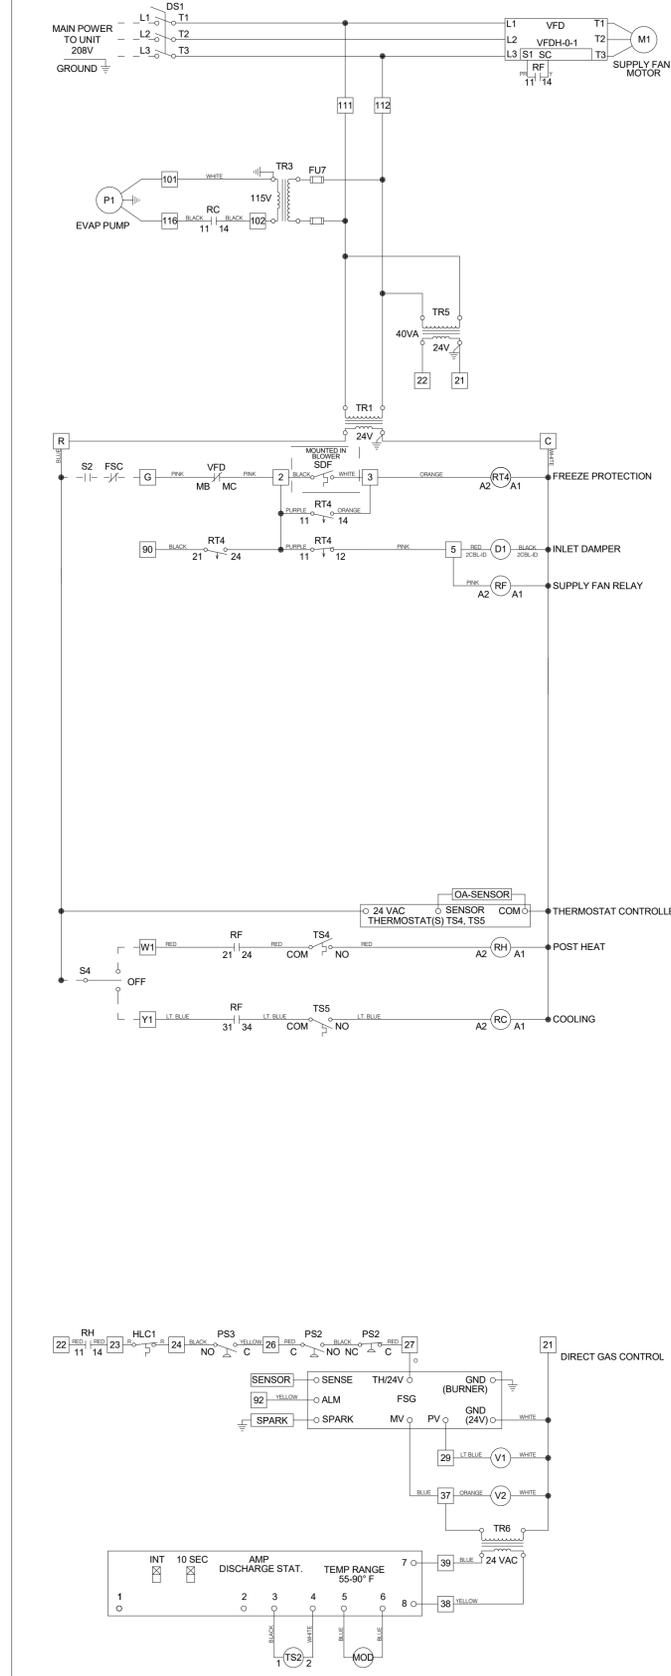

54 **MAU-HOOD CONTROLS**  
M-104 / N.T.S.

**CAUTION**  
UNIT SHALL BE GROUNDED IN ACCORDANCE WITH N.E.C. POWER MUST BE OFF WHILE SERVICING.

**NOTES**  
USE COPPER CONDUCTORS ONLY  
60° C FOR TERMINALS RATED LESS THAN 100 AMPS.  
75° C FOR TERMINALS RATED 100 AMPS OR MORE.  
FIELD CONTROL WIRING RESISTANCE SHOULD NOT EXCEED 0.75 OHM.  
FIELD WIRED - - - - -  
FACTORY SUPPLIED AND WIRED \_\_\_\_\_

WIRE COLOR CODE	
BK BLACK	BL BLUE
GY GRAY	LT BL LIGHT BLUE
PK PINK	PR PURPLE
W WHITE	Y YELLOW
BR BROWN	O ORANGE
	R RED

- LEGEND**
- AMP AMPLIFIER
  - D1 INLET DAMPER
  - DS1 MAIN DISCONNECT SWITCH
  - FSC FIRE SYSTEM CONTACT
  - FSG FLAME SAFE GUARD
  - FU# FUSE
  - HLC HIGH LIMIT CONTROL
  - MR MOTOR
  - MOD MODULATING VALVE
  - P# EVAP PUMP
  - PS1 DIRTY FILTER SWITCH
  - PS2 AIR PROOFING SWITCH
  - PS3 LOW GAS PRESSURE SWITCH
  - RC COOL RELAY
  - RF SUPPLY FAN RELAY
  - RF1 FAN ENABLE RELAY
  - RH HEAT RELAY
  - RT4 FREEZE PROTECTION TIMER SWITCH: 1 and 4 DOWN - 2 and 3 UP / DIAL SET TO 4
  - S2 FAN SWITCH
  - S4 HEAT AND COOL SWITCH
  - SDF SENSOR DISCHARGE - FREEZE
  - SG SPARK GENERATOR
  - ST# MOTOR STARTER
  - TR# TRANSFORMER
  - TS2 DISCHARGE AIR SENSOR
  - TS4 INLET AIR SENSOR - HEAT JUMPER = HEAT - DIFFERENTIAL = 2
  - TS5 INLET AIR SENSOR - COOL DIFFERENTIAL = 2 - OFFSET = 10
  - V1 PILOT VALVE
  - V2 MAIN VALVE
  - VFD VARIABLE FREQUENCY DRIVE


**USER INTERFACE CONNECTIONS:**  
USER TO VERIFY THAT TR1 CAN HANDLE THE VA LOAD OF INDICATOR DEVICES  
DIRTY FILTER INDICATOR SHOWN AS 24V POWER FROM UNIT.  
PS1 SUPPLY DIRTY FILTER SWITCH

NO.	DATE	DESCRIPTION




**KEYED NOTES**

- CONNECT TWO EXISTING SUPPLY DUCTS WITH SAME SIZE 28X20 DUCT.
- RE USE EXISTING 20X20 DUCT FOR RTU-KITCHEN RETURN. USE SAME ROOF PENETRATION FOR RISER.
- RE USE EXISTING ROOF PENETRATION FOR NEW MAKE UP AIR UNIT.
- CONNECT NEW EF-DISH DUCTWORK TO DISHWASHER VENT STACKS.
- RELOCATE EXISTING DIFFUSERS UNDER SUPPLY DUCT. PROVIDE NEW 10" CONICAL TAP AND FLEXIBLE DUCT. BALANCE TO REQUIRED AIRFLOW.
- BALANCE SUPPLY DIFFUSERS TO LISTED AIRFLOW. ADJUST AS NECESSARY TO FIT NEW CEILING.
- PROVIDE AND INSTALL UNION AND DIRT LEG PRIOR TO MAKING CONNECTION TO GAS FIRED APPLIANCE.
- PROVIDE AND INSTALL ADJUSTABLE ROLLER NON PENETRATING PIPE SUPPORT SIMILAR TO MAPA AT 8' O.C.
- 3/4" CONDENSATE DRAIN LINE GOES DOWN THROUGH THE ROOF. FOR CONTINUATION SEE WASTE AND VENT PLAN. PROVIDE LINE WITH P-TRAPS AS INDICATED ON SCHEMATIC PLANS.
- 1/2" COLD WATER LINE DOWN THROUGH THE ROOF. FOR CONTINUATION REFER TO HOT AND COLD WATER PLAN. CONNECT LINE TO MAKE UP AIR UNIT EVAPORATIVE MODULE. PROVIDE ISOLATION BALL VALVE. REFER TO EVAPORATIVE COOLER WATER SUPPLY/DRAIN SCHEMATIC.
- 3/4" DRAIN LINE FROM EVAPORATIVE COOLER GOES DOWN THROUGH THE ROOF. FOR CONTINUATION SEE WASTE AND VENT PLAN.
- CONNECT NEW GAS LINE SERVING RTU TO EXISTING 3/4" GAS LINE ON ROOF.
- EXTEND DUCT UP THRU THE ROOF. WEATHERPROOF AS PER ROOFING MANUFACTURERS RECOMMENDATIONS.
- DUCT TO HOOD JOINT SHALL COMPLY WITH IMC CODE 506.3.2.2. PROVIDE TWO LAYERS OF 3M FIRE DUCTWRAP FROM HOOD DUCT COLLAR TO BOTTOM OF ROOF DECK. SLOPE DUCTWORK 1/4" TOWARDS HOOD AS PER 2015 IMC AND PROVIDE 16X16 ACCESS DOOR AT BOTTOM OF EXHAUST PLENUM.
- CONNECT CONICAL TAP AND FLEXIBLE DUCT TO EXISTING SUPPLY MAIN. EXTEND A MAXIMUM OF 5' FLEX DUCT TO SERVE NEW SUPPLY DIFFUSER.
- INSTALL NEW KITCHEN HOOD CONTROL PANEL 5' A.F.F.

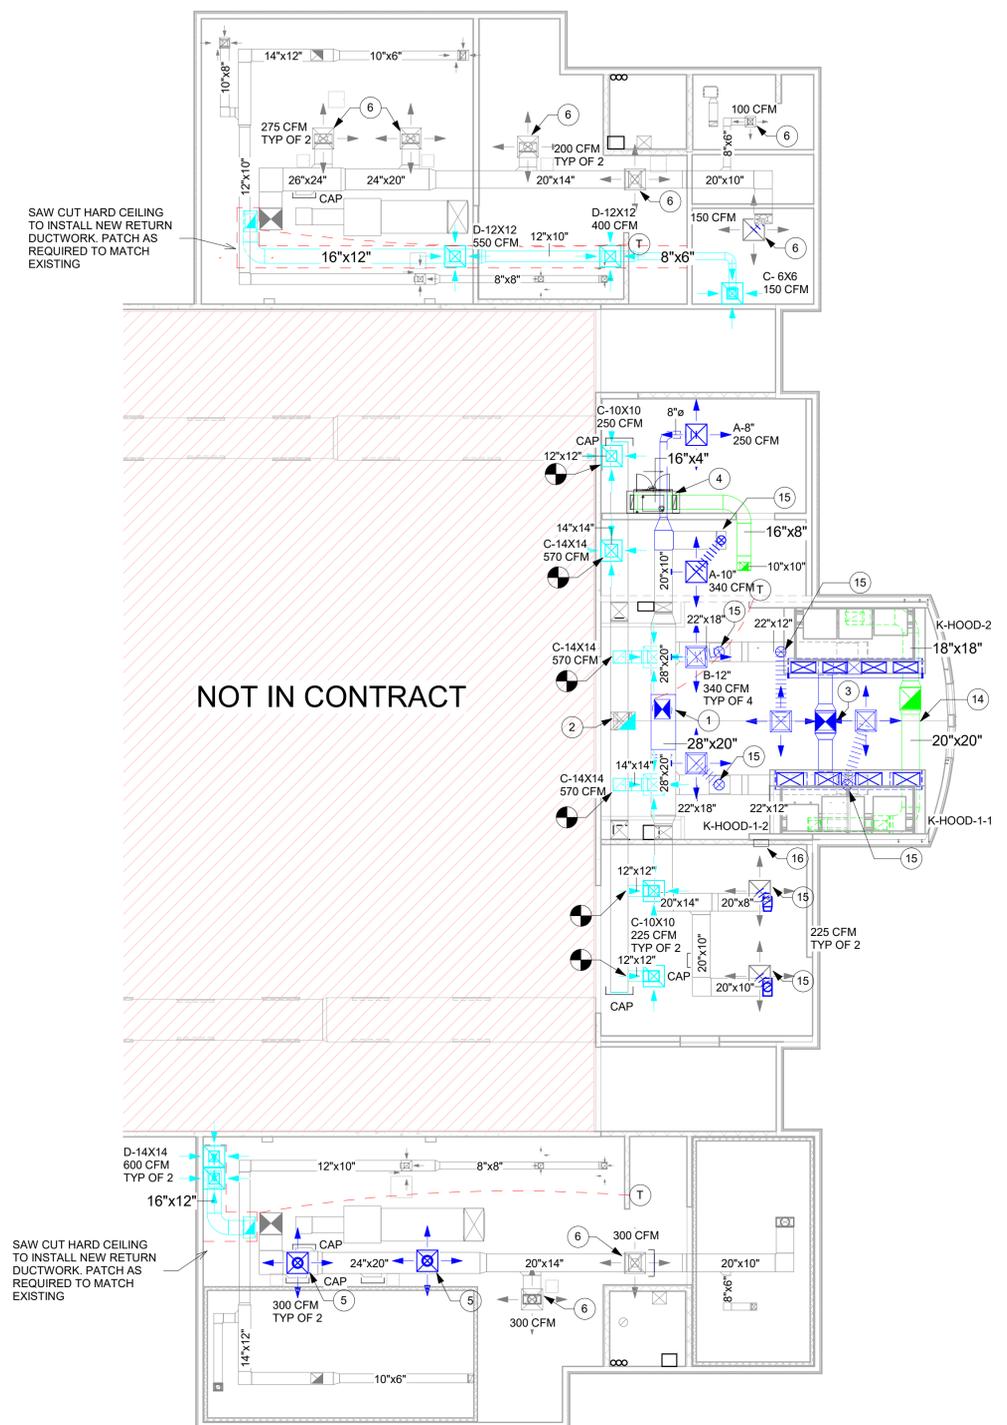


**1 1ST LEVEL MECHANICAL IMPROVEMENT PLAN**  
M-300 1/8" = 1'-0"

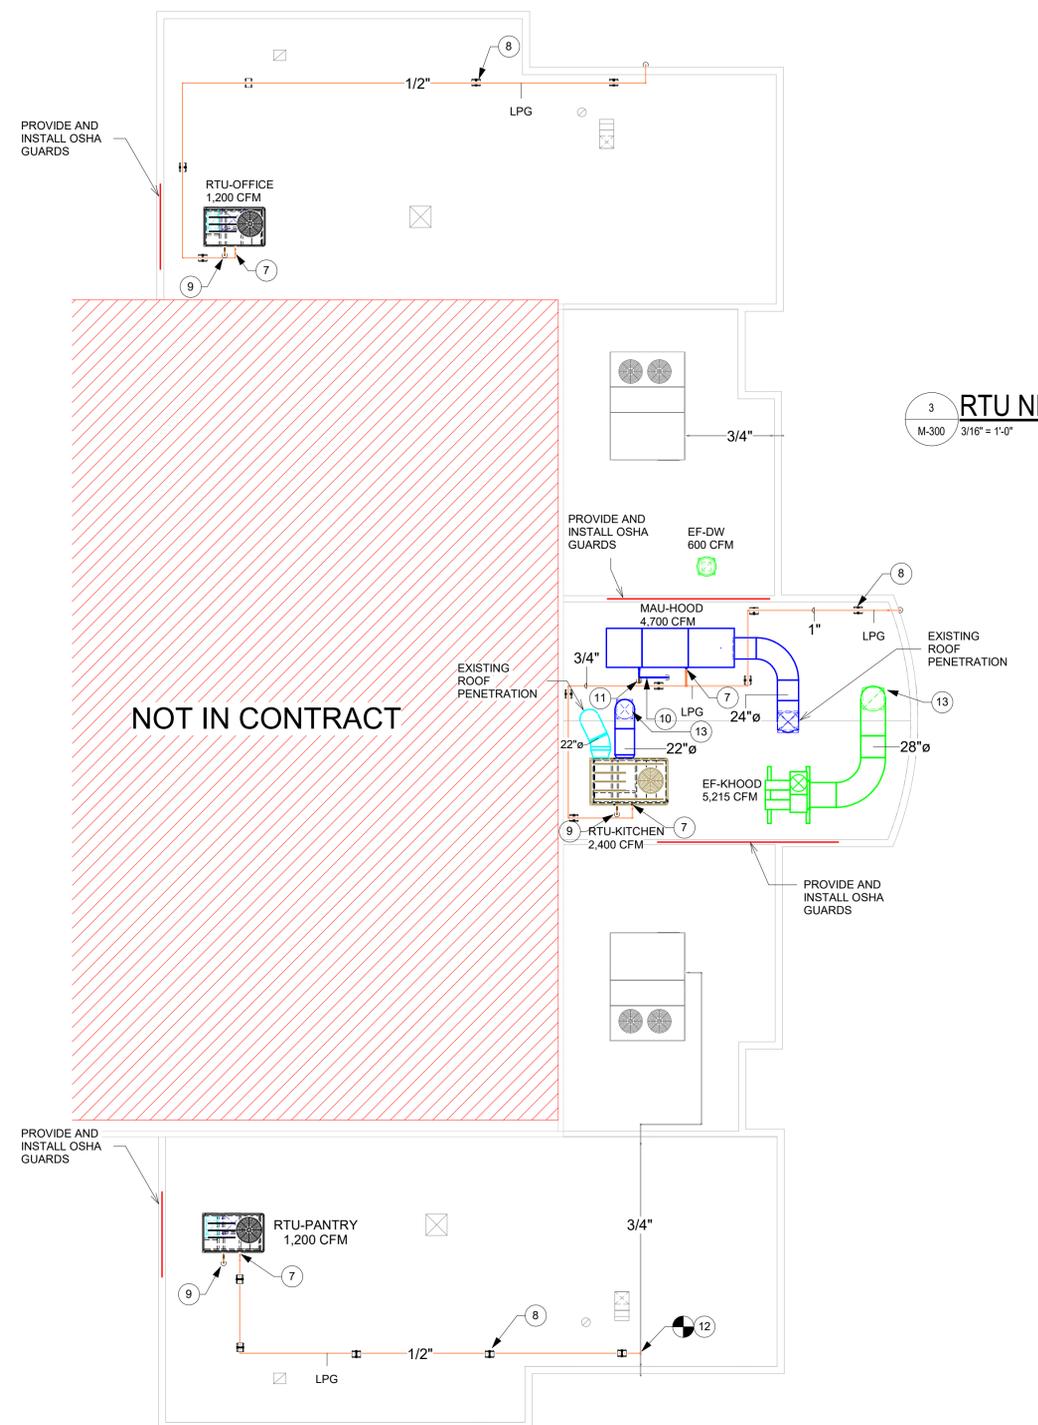


**2 ROOF MECHANICAL IMPROVEMENT PLAN**  
M-300 1/8" = 1'-0"

**3 RTU NEW GAS LINE CONNECTION**  
M-300 3/16" = 1'-0"

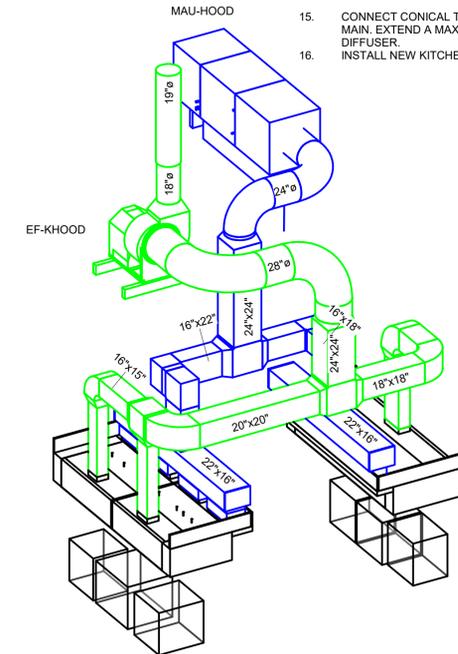

**4 KITCHEN HOODS ISOMETRIC VIEW**  
M-300 N.T.S.

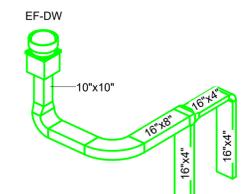

**5 DISHWASHER EF ISOMETRIC VIEW**  
M-300 N.T.S.

**Countryman & Co.**  
Architecture

108 SOUTH STANTON . THIRD FLOOR . EL PASO, TEXAS 79901 915.919.1827



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ISSUED: 10/24/2022


REVISION SCHEDULE:

NO.	DATE	DESCRIPTION

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**TORNILLO INDEPENDENT SCHOOL DISTRICT CAFETERIA CONVERSION**  
300 OIL MILL DR. | TORNILLO, TX 79853  
SHEET TITLE:  
**MECHANICAL IMPROVEMENT PLAN**

Project Status  
**M-300**

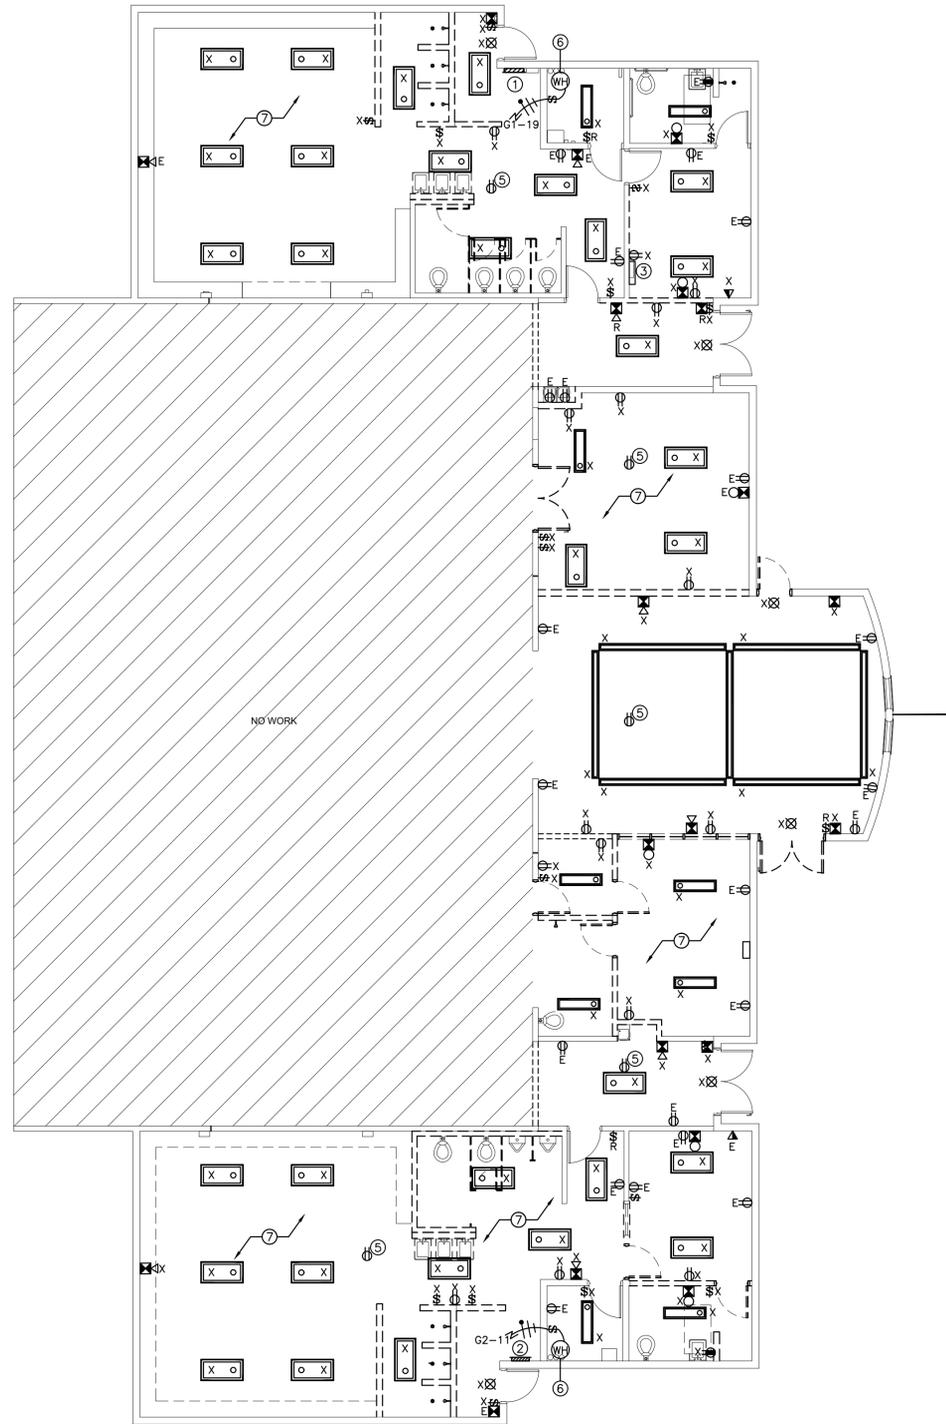

**KEYED NOTES:**

- ① APPROXIMATE LOCATION OF EXISTING 225A 120/208V, 3 PH, 4 WIRE PANELBOARD 'G1' TO BE REPLACED WITH NEW 225A, 120/208V, 3PH 4 WIRE PANELBOARD 'G1' SEE NEW PANEL SCHEDULE ON SHEET E4.0.
- ② APPROXIMATE LOCATION OF EXISTING 225A 277/480V, 3 PH, 4 WIRE PANELBOARD 'G2' TO BE REPLACED WITH NEW 225A, 120/208V, 3PH 4 WIRE PANELBOARD 'G2' SEE NEW PANEL SCHEDULE ON SHEET E4.0.
- ③ APPROXIMATE LOCATION OF SECURITY CABINET TO REMAIN.
- ④ APPROXIMATE LOCATION OF EXISTING FIRE ALARM CONTROL PANEL ON GYM ELECTRICAL ROOM
- ⑤ EXISTING ROOF GFI, WP ROOF TOP OUTLETS TO REMAIN.
- ⑥ EXISTING WATER HEATER AND ASSOCIATED EQUIPMENT TO BE REPLACED WITH NEW. CONTRACTOR TO RE-USE EXISTING CIRCUIT AS NOTED. MAKE CONNECTIONS AS NECESSARY.
- ⑦ ALL EXISTING FIXTURES TO BE REMOVED. CONTRACTOR TO MAINTAIN EXISTING LIGHT CIRCUIT FOR NEW FIXTURES.

ELECTRICAL DEMOLITION SYMBOL LEGEND	
SYMBOL	DESCRIPTION
	EXISTING FLUORESCENT FIXTURE TO BE REMOVED.
	EXISTING EXIT LIGHT FIXTURE TO BE REMOVED.
	EXISTING EMERGENCY LIGHT FIXTURE TO BE REMOVED.
	EXISTING SINGLE POLE WALL SWITCH TO BE REMOVED.
	EXISTING THREE-WAY WALL SWITCH TO BE REMOVED.
	EXISTING JUNCTION BOX TO BE REMOVED.
	EXISTING DUPLEX OUTLET. NO WORK REQUIRED.
	EXISTING DUPLEX OUTLET TO BE REMOVED.
	EXISTING QUADRUPLEX RECEPTACLE TO BE REMOVED.
	EXISTING DATA/TEL. SYSTEM OUTLET. NO WORK REQUIRED.
	EXISTING DATA/TEL. SYSTEM OUTLET TO BE REMOVED.
	RELOCATED QUADRUPLEX RECEPTACLE, CONNECT TO EXISTING CIRCUIT
	EXISTING SPEAKER TO REMAIN, EXTEND EXISTING P.A. ZONE AS REQUIRED
	EXISTING SPEAKER TO BE REMOVED.
	EXISTING F.A. SMOKE DETECTOR TO BE REMOVED EXTEND EXISTING ZONE AS REQUIRED.
	EXISTING F.A. HORN/STROBE TO BE RELOCATED, EXTEND EXISTING F.A. ZONE AS REQUIRED.
	EXISTING F.A. HORN/STROBE TO BE REMOVED.
	EXISTING F.A. PULLSTATION TO BE RELOCATED, EXTEND EXISTING F.A. ZONE AS REQUIRED
	EXISTING F.A. PULLSTATION TO BE REMOVED.
	EXISTING FIRE ALARM CONTROL PANEL
	DISCONNECT, TO BE NEMA 3R IF INSTALLED OUTDOORS.
	EXISTING PANELBOARD TO REMAIN. NO WORK REQUIRED UNLESS NOTED.

**DEMOLITION GENERAL NOTES:**

- A. CONTRACTOR MUST VISIT SITE BEFORE BIDDING ON THIS PROJECT. VERIFY ALL DEVICES BEING REMOVED ONLY IN THE AREAS THAT ARE TO BE RENOVATED. CONTRACTOR MUST COORDINATE WITH ARCHITECTURAL PLANS AND OWNER FOR EXTENT OF DEMOLITION.
- B. CONTRACTOR TO REMOVE ALL ELECTRICAL DEVICES ASSOCIATED WITH MECHANICAL EQUIPMENT BEING REMOVED. COORDINATE WITH MECHANICAL PLANS FOR EXTENT OF HVAC DEMOLITION. REMOVE CONDUIT AND CONDUCTORS BACK TO SOURCE AND UPDATE PANEL DIRECTORY AS REQUIRED.
- C. CONTRACTOR TO MAINTAIN CIRCUIT CONTINUITY FOR ALL DEVICES OUT OF DEMOLITION WORK. CONTRACTOR TO PROVIDE AND INSTALL ALL NECESSARY MATERIALS TO MAINTAIN CIRCUIT CONTINUITY FOR REMAINING DEVICES. PROVIDE TYPED CIRCUIT DIRECTORY WITH ALL UPDATED CIRCUITING.
- D. CONTRACTOR IS TO DISPOSE ALL MATERIALS ACCORDING TO LOCAL, STATE, AND FEDERAL REGULATIONS.
- E. EXISTING LIGHTING CIRCUITS TO REMAIN FOR REUSE. CONTRACTOR TO EXTEND EXISTING CONDUIT AND CIRCUITS AS NECESSARY TO RECONNECT RELOCATED LIGHT FIXTURES, OR NEW LIGHT FIXTURES.
- F. CONTRACTOR MUST COORDINATE WITH ARCHITECTURAL PLANS FOR EXTENT OF DEMOLITION TO AVOID CONFLICTS WITH THE NEW WORK.

01 ELECTRICAL DEMOLITION PLAN  
1/8" = 1'-0"



Countryman & Co.  
Architecture

108 SOUTH STANTON . THIRD FLOOR . EL PASO, TEXAS 79901 915.929.1827



DRAWN BY: A.P/A.E/E  
PROJECT NO: 2022-16  
ISSUED: SEPTEMBER 30, 2022

REVISION SCHEDULE:

NO.	DATE	DESCRIPTION

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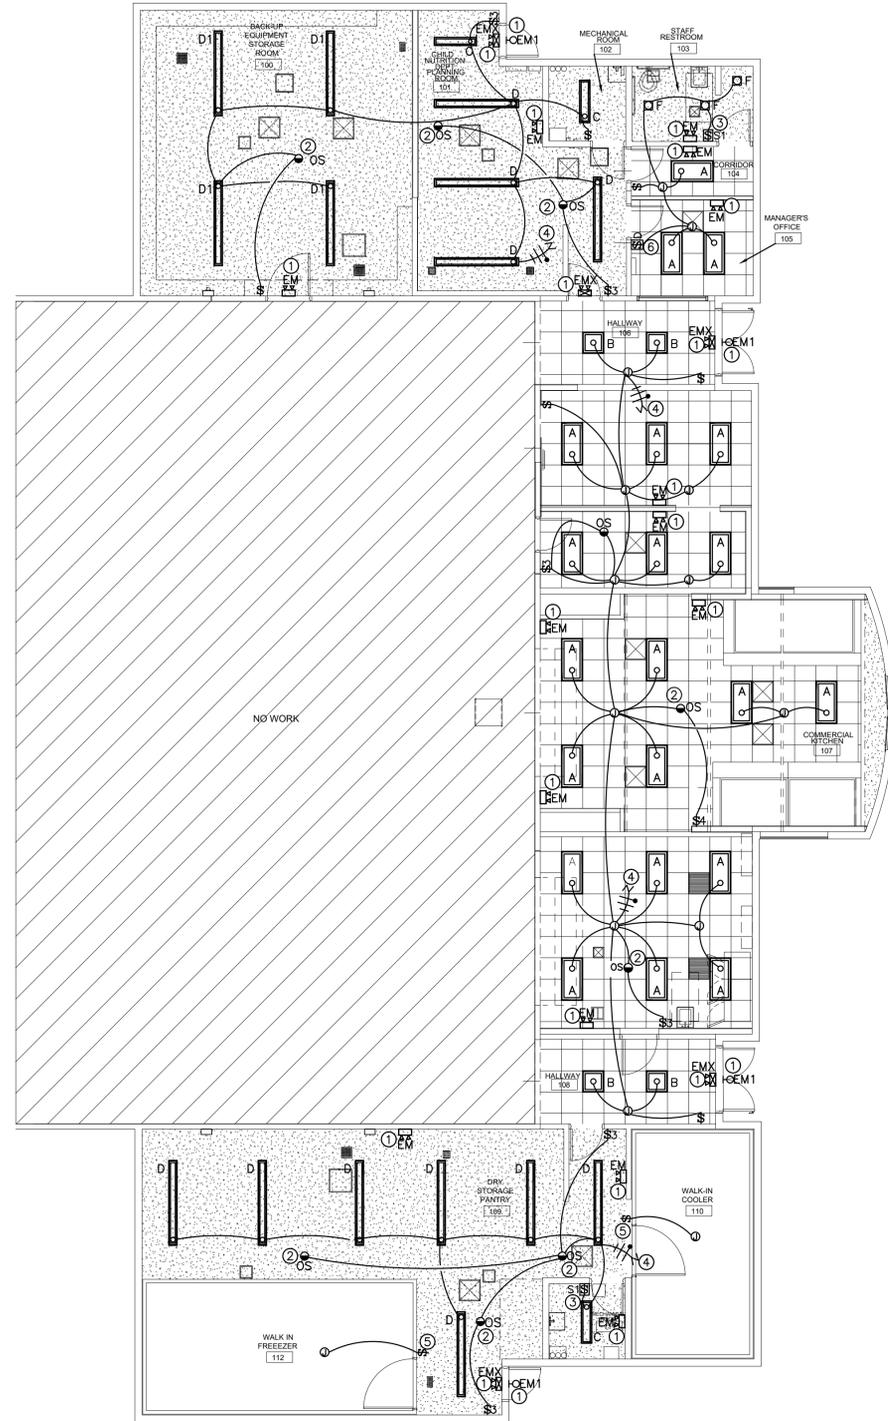
SHFFT TITLE:  
**ELECTRICAL DEMOLITION PLAN**

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ALPHA ENGINEERING, INC.  
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REGISTRATION # F005236

SCHEMATIC DESIGN

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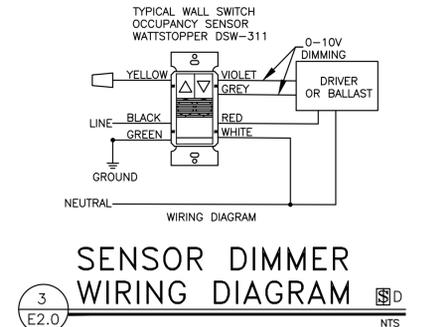
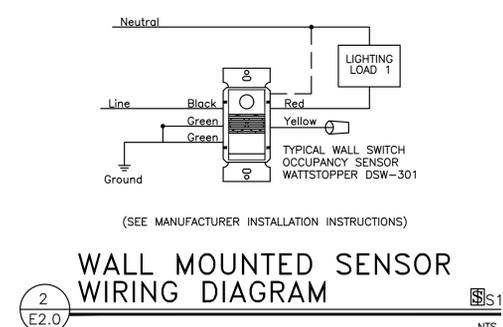
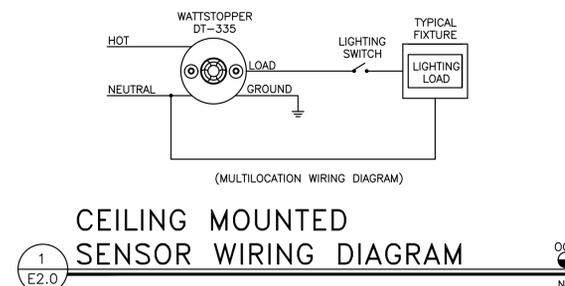
FIXTURE SCHEDULE				
TYPE	DESCRIPTION & MFR. CAT. No.	LAMPS & WATTS	MOUNTING	NOTES
A	METALUMEN TC5-2L35K-24-PCB24-W-L2	30W LED	RECESSED GRID CEILING	
B	METALUMEN TC5-2L35K-22-PCB24-W-L2	25W LED	RECESSED GRID CEILING	
C	WILLIAMS LIGHTING 75S-4-L50-840-DIM-UNV	34W LED	SURFACE	
D	WILLIAMS LIGHTING 75S-8-L60-840-DIM-UNV	35W LED	SURFACE	
D1	WILLIAMS LIGHTING 75S-8-L100-840-DIM-UNV	65W LED	SURFACE	
F	WILLIAMS LIGHTING 6DS-L20-835-DIM-UNV-L-W-OF-WH	22W LED	SURFACE	
EM1	CHLORIDE PLACEMBZ	LED INCLUDED	WALL	
EMX	CHLORIDE VERWEM	LED INCLUDED	WALL/CEILING	
X1	CHLORIDE VERW	LED INCLUDED	WALL/CEILING	

LIGHTING CONTROLS LEGEND		
DEVICE	MODEL	DESCRIPTION
OS	DSW-301 OR EQUAL	WATTSTOPPER SENSOR WALL SWITCH DUAL TECHNOLOGY, SELF POWERED, ONE SWITCH, 48" TO TOP OF BOX
OS	DT-355 OR EQUAL	WATTSTOPPER CEILING MOUNTED DUAL-TECHNOLOGY, 1000 SQ FT, LINE VOLTAGE
D		DIMMER SWITCH LUTRON DIVA DVSTV-1, 48" TO TOP OF BOX

NOTES:

- All sensor locations are approximate, refer to manufacturers installation instructions prior to installation.
- Ultrasonic ceiling mount sensors should be located a minimum of six feet from HVAC supply/return vents.
- Contractor is responsible for proper sensitivity & time delay settings (for non-adaptive products), recommended placement, and field verification of circuits with respect to power placement.
- Sensors mounted over the door must be placed one foot inside the threshold.
- Contractor is responsible for ensuring that the sensor bill of materials complies with the sensor design and layout specifications.
- Contractor is responsible for installing equipment in compliance with local code.
- All sensors to be set to turn off lighting after 15 minutes of no motion sensing.
- Wall mounted occupancy sensors must not be installed behind doors.
- Contractor may connect low voltage system in daisy chain to minimize LV cable runs.
- Dimmer switches must be installed in individual boxes.
- Dimmer switches must be light fixture compatible. Verify compatibility with light fixture manufacturers.

- KEYED NOTES:**
- ALL EXIT SIGNS, EMERGENCY LIGHTS, OR BATTERY BACKUPS MUST BE CONNECTED TO THE UN-SWITCHED HOT CONDUCTOR SERVING THIS AREA.
  - PROVIDE AND INSTALL CEILING MOUNTED, DUAL TECHNOLOGY, LINE VOLTAGE, OCCUPANCY SENSOR WATTSTOPPER MODEL DT-355 OR EQUAL APPROVED BY ENGINEER. PROGRAM SENSOR FOR AUTO-OFF FUNCTION ONLY. AUTO-OFF FUNCTION TO BE SET TO TURN OFF ALL LIGHTS IN THIS ROOM AFTER 15 MIN OF NO MOTION SENSING. SEE DETAIL 1/E2.0.
  - PROVIDE AND INSTALL WALL MOUNTED, DUAL TECHNOLOGY, LINE VOLTAGE, OCCUPANCY SENSOR WATTSTOPPER MODEL DSW-301 OR EQUAL APPROVED BY ENGINEER. PROGRAM SENSOR FOR AUTO-OFF/AUTO-ON FUNCTION. AUTO-OFF FUNCTION TO BE SET TO TURN OFF ALL LIGHTS IN THIS ROOM AFTER 15 MIN. OF NO MOTION SENSING. SEE DETAIL 2/E2.0.
  - CONTRACTOR TO CONNECT NEW LIGHT FIXTURE TO EXISTING CIRCUIT MAINTAINED DURING DEMOLITION. EXTEND EXISTING CIRCUIT AND CONDUIT AS NECESSARY TO MAKE RECONNECTIONS.
  - PROVIDE AND INSTALL SWITCH FOR WALK-IN COOLER/FREEZER LIGHT. CONTRACTOR TO MAKE CONNECTIONS TO EXISTING LIGHTING CIRCUIT SERVING THIS AREA.
  - PROVIDE AND INSTALL WALL MOUNTED OCCUPANCY DIMMING SENSOR DUAL TECHNOLOGY WATTSTOPPER DW-311 OR EQUAL. SENSOR TO BE SET FOR AUTO-ON/AUTO-OFF FUNCTION. AUTO-ON FUNCTION TO BE SET TO TURN ON ONLY 50% OF EACH LIGHT FIXTURE. AUTO-OFF FUNCTION TO BE SET TO TURN OFF LIGHTS AFTER 15 MIN. OF NO MOTION SENSING. REFER TO DETAIL 3/E2.0.



01 POWER PLAN  
1/8" = 1'-0"

Countryman & Co.  
Architecture

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DRAWN BY: A.P/A/E/E  
PROJECT NO: 2022-16  
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SHEET TITLE:  
LIGHTING PLAN

E2.0



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REGISTRATION # F005236

SCHEMATIC DESIGN

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NEW PANELBOARD SCHEDULE					
PANELBOARD "G1": 120/208V, 3 PHASE, 4 WIRE, 225 AMP. PANEL RECESSED MOUNTED, CU BUS, CU NEUTRAL BAR, DOOR-IN-DOOR 200A MAIN C.B.					
LOAD SERVED	CKT. NO.	BREAKER AMPS, POLE	PHASE A B C	BREAKER AMPS, POLE	LOAD SERVED
EXISTING GIRLS LOCKER LIGHTS	1	20/1		100	2
EXISTING STORAGE LIGHTS	3	20/1		3	4
SOLID DOOR	5	20/1			6
HEATED CABINET	7	20/1		20/1	8
GAS CONVECTION OVEN	9	20/1		20/1	10
EXISTING EWH MOTOR	11	20/1		20/1	12
EXISTING COACH OUTLETS	13	20/1		20/1	14
EXISTING EWC	15	20/1		20/1	16
EXISTING GYM OUTLETS	17	20/1		20/1	18
EXISTING STORAGE OUTLETS	19	20/1		20/1	20
MILK COOLER (1)	21	20/1		20/1	22
GAS CONVECTION OVEN (1)	23	20/1		20/1	24
HOT FOOD SERVING COUNTER (1)	25	20/1		20/1	26
SERVING COUNTER, COLD FOOD (1)	27	20/1		20/1	28
CONVECTION OVEN GAS (1)	29	20/1		20/1	30
RTU-KITCHEN 208V, 3PH 4 WIRE.	31	50		20/1	32
	33	3		30	34
	35	3		2	36
RTU-OFFICE 208V, 3PH	37	30		30	38
	39	3		30	40
	41	3		3	42
DISHWASHER HOOD EXHAUST 208V, 3PH	43	25		20/1	44
	45	3		20/1	46
	47	3		20/1	48
ROLL UP DOOR	49	20/1		--	50
ICE MAKER (1)	51	20/1		--	52
SPACE	53	--		--	54

(1) PROVIDE AND INSTALL A NEW 20A, 1 POLE, GROUND FAULT INTERCEPT CIRCUIT BREAKER

**PANELBOARD "G1" LOAD CALCULATIONS**

	LOAD (VA)
KITCHEN EQUIPMENT PER NEC 220.36 @ 65%	11,500
EXISTING LOAD ESTIMATED	16,400
RTU	12,600
AC1	5,037
OUTLETS	4,900
<b>TOTAL</b>	<b>50,450</b>

$I = 50,450 \text{ VA} / (208\text{V})(1.73) = 140\text{A}$  AMPS  
225 AMP, 120/208V, 3 PH., 4W, PANEL "G1" FED FROM A 200A 3PH, 4W, DISC. "G1" FUSED AT 200A EXISTING 2" CONDUIT WITH 4-3/0 THWN CU. CONDERS. 1-#6 CU. COND. FOR EQUIPMENT GND. TO REMAIN.

NEW PANELBOARD SCHEDULE					
PANELBOARD "G2": 120/208V, 3 PHASE, 4 WIRE, 225 AMP. PANEL RECESSED MOUNTED, CU BUS, CU NEUTRAL BAR, DOOR-IN-DOOR, 200A MAIN C.B.					
LOAD SERVED	CKT. NO.	BREAKER AMPS, POLE	PHASE A B C	BREAKER AMPS, POLE	LOAD SERVED
EXISTING BOYS LOCKER LIGHTS	1	20/1		100	2
EXISTING TRAINER'S LIGHTS	3	20/1		3	4
EXISTING WEIGHT ROOM LIGHTS	5	20/1			6
EXISTING WEIGHT ROOM LIGHTS	7	20/1		40	8
SPACE	9	--		3	10
SPACE	11	--			12
EXISTING TRAINERS' OUTLETS	13	20/1		30	14
EXISTING COACH 119 OUTLETS	15	20/1		3	16
EXISTING LOCKERS 125 OUTLETS	17	20/1		3	18
EXISTING EWH MOTOR	19	20/1		30	20
EXISTING WEIGHT RM. OUTLETS	21	20/1		3	22
EXISTING WEIGHT RM. OUTLETS	23	20/1			24
EXISTING EWC	25	20/1		--	26
SERVING COUNTER, UTILITY OUTLET (1)	27	20/1		--	28
KITCHEN OUTLET (1)	29	20/1		30	30
SERVING COUNTER, COLD FOOD (1)	31	20/1		2	32
	33	25		30	34
	35	2		3	36
3 SOLID DOOR REFRIGERATOR	37	20/1			38
ROLL UP DOOR	39	20/1		20/1	40
STORAGE OUTLETS	41	20/1		20/1	42
SPACE	43	--		20/1	44
SPACE	45	--		--	46
SPACE	47	--		--	48
SPACE	49	--		--	50
SPACE	51	--		--	52
SPACE	53	--		--	54

(1) PROVIDE AND INSTALL A NEW 20A, 1 POLE, GROUND FAULT INTERCEPT CIRCUIT BREAKER

**PANELBOARD "G2" LOAD CALCULATIONS**

	LOAD (VA)
KITCHEN EQUIPMENT PER NEC 220.36 @ 65%	5,400
EXISTING LOAD ESTIMATED	21,800
MUA-1	7,900
EXHAUST	4,000
(2) CONDENSORS	7,670
<b>TOTAL</b>	<b>46,770</b>


$I = 46,770 \text{ VA} / (208\text{V})(1.73) = 130\text{A}$  AMPS  
225 AMP, 120/208V, 3 PH., 4W, PANEL "G2" FED FROM A 200A 3PH, 4W, DISC. "G2" FUSED AT 200A EXISTING 2" CONDUIT WITH 4-3/0 THWN CU. CONDERS. 1-#6 CU. COND. FOR GND. TO REMAIN.

**GENERAL NOTES:**

- ELECTRICAL INSTALLATION MUST FOLLOW ALL NATIONAL AND LOCAL ELECTRICAL CODES. INSTALLATION MUST CONFORM TO THE LOCAL POWER COMPANY'S SPECIFICATIONS.
- ELECTRICAL CONTRACTOR MUST COORDINATE AND VERIFY WITH MECHANICAL AND PLUMBING CONTRACTOR THE LOCATION AND ELECTRICAL REQUIREMENTS TO ALL A/C EQUIPMENT, MOTORS, PUMPS, T-STATS., INTERLOCKING WIRING, ETC.
- ALL MATERIALS SHALL BE IN ACCORDANCE WITH THE NATIONAL ELECTRICAL MANUFACTURERS ASSOCIATION AND SHALL BE LISTED BY THE U.L.
- ELECTRICAL CONTRACTOR MUST COORDINATE ALL POWER SERVICE ON THIS PROJECT. THE CONTRACTOR IS RESPONSIBLE FOR ALL FEES FOR TEMPORARY SERVICE.
- ELECTRICAL CONTRACTOR IS RESPONSIBLE FOR ALL PERMIT AND INSPECTION FEES REQUIRED BY THE GOVERNING BODIES.
- ELECTRICAL CONTRACTOR MUST COMPLY WITH THE LATEST A.D.A. REQUIREMENTS.
- MINIMUM SIZE CONDUCTORS SHALL BE #12 THW CU. UNLESS NOTED OR SIZED BY CODE.
- ALL WIRING MUST BE IN CONDUIT, INCLUDING ALL L.V. WIRING. THIN WALL CONDUIT (EMT) CAN BE INSTALLED CONCEALED ABOVE CEILING, IN FURRED WALLS, AND WALLS EXCEPT WHERE THOSE WALLS ARE GROUTED SOLID. USE FLEX CONDUIT FOR MOTORS AND LIGHTING FIXTURES. USE WATER TIGHT FLEX CONDUIT FOR WATER HEATERS, DISPOSALS, EXTERIOR CONNECTIONS, ETC. BOND ACCORDING TO CODE.
- FIXTURES. USE WATER TIGHT FLEX CONDUIT FOR WATER HEATERS DISPOSALS, EXTERIOR CONNECTIONS, ETC. BOND ACCORDING TO CODE.
- VERIFY LOCATIONS OF ALL ELECTRICAL EQUIPMENT WITH OTHER TRADES TO AVOID CONFLICTS AND INTERFERENCES.
- CONTRACTOR MUST VISIT SITE TO BECOME FAMILIAR WITH EXISTING CONDITIONS BEFORE BIDDING ON THIS PROJECT.
- ELECTRICAL DEVICE INSTALLATION SHALL COMPLY WITH ACCESSIBILITY CODES ADOPTED IN CITY OF EL PASO.
- FEEDER, BRANCH CIRCUIT DESIGN, AND INSTALLATION SHALL COMPLY WITH THE LATEST ADOPTED CITY OF EL PASO ELECTRICAL CODE 18.16 AND NFPA 70 (NEC).
- ALL ELECTRICAL EQUIPMENT IN FIRE RATED ASSEMBLIES MUST BE INSTALLED SO THAT FIRE RATING IS NOT COMPROMISED. ELECTRICAL CONTRACTOR MUST INSTALL FIRE-STOPPING SEALS AND MATERIALS AS NECESSARY ON ALL PENETRATIONS MADE ON ALL FIRE RATED ASSEMBLIES TO MATCH FIRE RATING.
- BRANCH CIRCUIT NUMBERS ARE TO BE WRITTEN WITH BLACK INK MARKERS ON ALL COVERS OF ALL JUNCTION BOXES LOCATED ABOVE CEILING. MARKINGS MUST INDICATE THE PANEL AND CIRCUIT NUMBER OF CIRCUITS IN THAT BOX.
- MC CABLE IS NOT ALLOWED FOR ELECTRICAL INSTALLATIONS EXCEPT FOR LIGHT FIXTURE WHIPS.
- ALL ELECTRICAL DEVICE COVER PLATES SHALL BE PROVIDED WITH A ADHESIVE PERMANENT VINYL PRINTED LABEL INDICATING PANEL NAME AND CIRCUIT NUMBER. I.E. "X"-"XX" WHERE "X" IS THE PANEL NAME AND "XX" IS THE CIRCUIT NUMBER.
- ALL 15A & 20A, 125 AND 250-VOLT NON-LOCKING TYPE RECEPTACLES MUST BE LISTED TAMPER-RESISTANT RECEPTACLES TO COMPLY WITH NEC ART 406.12.
- ALL GFCI RECEPTACLES MUST BE INSTALLED IN A READILY ACCESSIBLE LOCATION TO COMPLY WITH NEC ART 210.8.

**ELECTRICAL SYMBOL LEGEND**


SYMBOL	DESCRIPTION
A	LED FIXTURE, LETTER DENOTES TYPE
A	LED FIXTURE, UPPERCASE LETTER DENOTES FIXTURE TYPE, LOWERCASE LETTER DENOTES WHICH SWITCH IS CONTROLLING FIXTURE.
B	2X2 LED FIXTURE, UPPERCASE LETTER DENOTES FIXTURE TYPE.
G	WALL MOUNTED FIXTURE, LETTER DENOTES TYPE
G	CEILING MOUNTED FIXTURE, LETTER DENOTES TYPE
X1	EXIT LIGHT FIXTURE, CONNECT TO UNSWITCHED HOT CONDUCTOR.
G	RECESSED FIXTURE, LETTER DENOTES TYPE
EM	EMERGENCY LIGHTS FIXTURE, CONNECT TO UNSWITCHED HOT CONDUCTOR.
EMX	COMBINATION EXIT/EMERGENCY LIGHT FIXTURE, CONNECT TO UNSWITCHED HOT CONDUCTOR.
EF	EXHAUST FAN, SEE MECHANICAL PLANS
Ⓢ	KEYED NOTE SYMBOL-ELECTRICAL
Eug	ELECTRICAL UNDERGROUND CIRCUIT, 2'-0" MINIMUM BELOW GRADE.
LV	LOW VOLTAGE WIRING CIRCUIT
WP	WEATHERPROOF
AFF	ABOVE FINISHED FLOOR
	BRANCH CIRCUIT IN WALLS OR CEILING.
----	BRANCH CIRCUIT UNDER FLOOR.
\$	SINGLE POLE WALL SWITCH, 44" TO CENTER OF BOX. UNLESS OTHERWISE NOTED.
\$3	THREE-WAY WALL SWITCH, 44" TO CENTER OF BOX UNLESS OTHERWISE NOTED.
\$4	FOUR-WAY WALL SWITCH, 44" TO CENTER OF BOX. UNLESS OTHERWISE NOTED.
◀	4" SQ. DEEP BOX WITH SINGLE DEVICE PLASTER RING FOR DATA/TEL. SYSTEM OUTLET AT 18" AFF TO CENTER UNLESS OTHERWISE NOTED. INSTALL 1" COND. WITH BUSHING AND PULL-STRING. STUB-OUT CONDUIT ABOVE NEAREST ACCESSIBLE LAY-IN CEILING.
Ⓢ	JUNCTION BOX
Ⓢ	CONTROLS FOR EXHAUST FANS IN MECHANICAL
Ⓢ	JUNCTION BOX INSTALLED ABOVE THE CEILING WITH FLEXIBLE CONDUIT CONNECTION TO LAY-IN FIXTURES. MAXIMUM 6'-0" LENGTH OF CONDUIT WITH REQUIRED CONDUCTORS ALONG WITH GREEN WIRE GROUND.
Ⓢ	DUPLEX OUTLET, 18" A.F.F. TO CENTER OF BOX, UNLESS OTHERWISE NOTED
Ⓢ-GFI	GROUND FAULT CIRCUIT INTERRUPTING DUPLEX RECEPTACLE, 18" A.F.F., TO CENTER, UNLESS OTHERWISE NOTED
Ⓢ	RECEPTACLE, 125/250VAC - 30A. NEMA 6-30R, 18" A.F.F. TO CENTER UNLESS OTHERWISE NOTED
Ⓢ	QUADRUPLEX RECEPTACLE, 125VAC-20A, NEMA 5-20R, 18" A.F.F., TO CENTER UNLESS OTHERWISE NOTED
Ⓢ	STUBB-UP RECEPTACLE. SEE DETAIL 1/E4.0.
Ⓢ	4" SQ. BOX WITH SINGLE DEVICE PLASTER RING AT 44" A.F.F TO CENTER OF BOX FOR THERMOSTAT. THERMOSTAT PROVIDED BY MECHANICAL CONTRACTOR
▬	NEW PANEL BOARD. SEE PANEL SCHEDULE FOR CHARACTERISTICS.
▬▬▬	EXISTING PANEL BOARD TO REMAIN. NO WORK REQUIRED UNLESS NOTED.
Ⓢ	DISCONNECT, TO BE NEMA 3R IF INSTALLED OUTDOORS.
Ⓢ	MOTOR CONTROLLER, SIZE AND POLES FOR MOTOR FURNISHED.
Ⓢ	TRANSFORMER AS NOTED

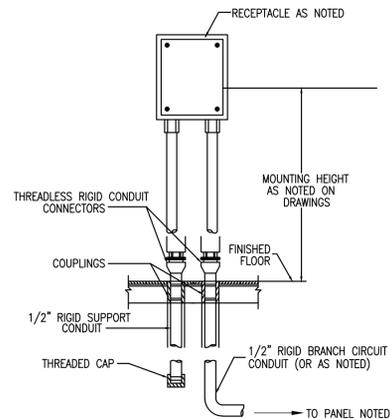

**DETAIL-WATERPROOF PEDESTAL BOX ASSEMBLY**

1  
E4.0

NTS

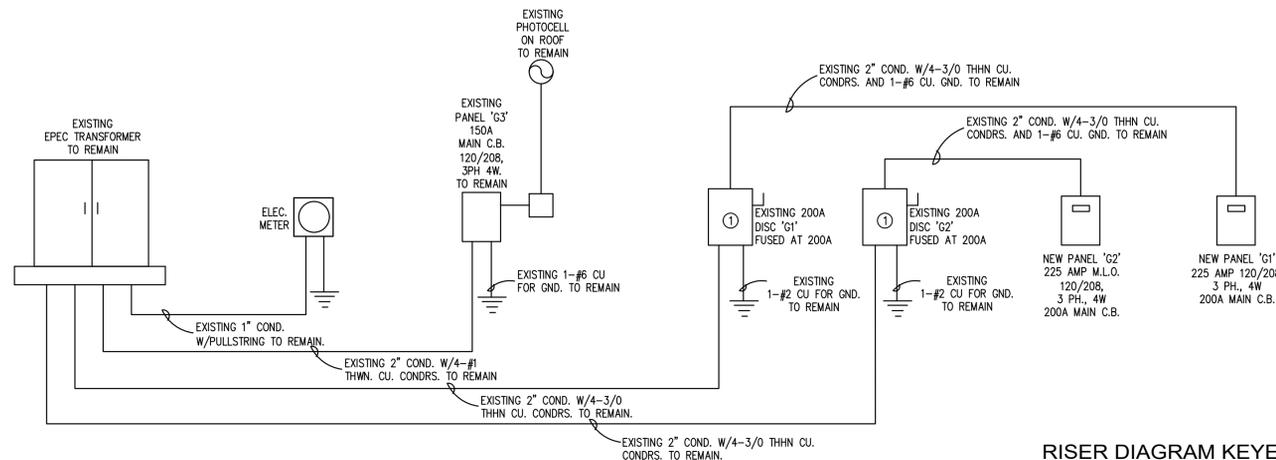

**ELECTRICAL RISER DIAGRAM**

NTS

**RISER DIAGRAM KEYED NOTES:**

- EXISTING 150A FUSES TO BE REPLACED WITH NEW 200A FUSES.
- CONTRACTOR TO REPLACE EXISTING 225A, 120/208V, 3PH, 4WIRE, PANEL WITH NEW 225A, 120/208V, 3PH, 4WIRE, PANELBOARD WITH A 200A MAIN C.B.



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SCHEMATIC DESIGN

**Countryman & Co.**  
Architecture

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DRAWN BY: A.P/A/E/E  
PROJECT NO: 2022-16  
ISSUED: SEPTEMBER 30, 2022

**REVISION SCHEDULE:**

NO.	DATE	DESCRIPTION


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**SHEET TITLE: RISER DIAGRAM**

**E4.0**


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**CONTRACTOR 'C1' WIRING DIAGRAM KEYED NOTES:**

- 1 CONTACTOR 'C1', ELECTRICALLY HELD, 10 POLE, 50 AMPS, 24 VOLT RATING, NEMA 1 ENCLOSURE. LABEL 'RKH' WITH ENGRAVED NAMEPLATE ATTACHED WITH SCREWS, INTERCONNECT TO FIRE SUPPRESSION SYSETEM. INSTALL ABOVE PANEL 'K' AND ABOVE CEILING IN KITCHEN.
- 2 PROVIDE AND INSTALL A NEMA 1 RATED ENCLOSURE WITH ENGRAVED NAMEPLATE ATTACHED WITH SCREWS LABLED 'RKH'. PROVIDE A (TEN) 10 POLE, ELECTRICALLY HELD, 50 AMPS, 600 VOLT RATING CONTACTOR FOR EMERGENCY SHUT DOWN OF DEVICES. INTERCONNECT RELAY 'RKH' WITH THE FIRE SUPPRESSION SYSTEM, SO WHEN FIRE SUPPRESSION SYSTEM IS ACTIVATED RELAYS SHALL SHUT DOWN ALL CIRCUITS UNDER KITCHEN HOOD. MAKE ALL CONNECTIONS AS REQUIRED.

**1** CONTACTOR 'C1' WIRING DIAGRAM  
E5.0 N.T.S.

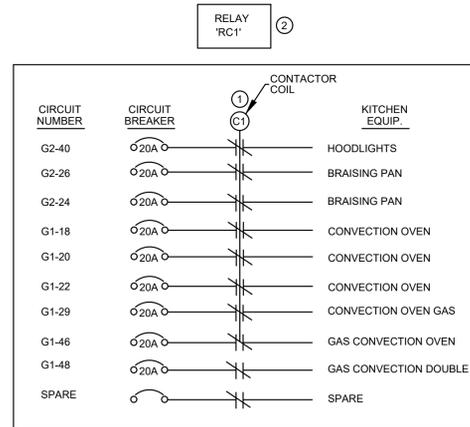

**KITCHEN HOOD CONTROL PANEL KEYED NOTES:**

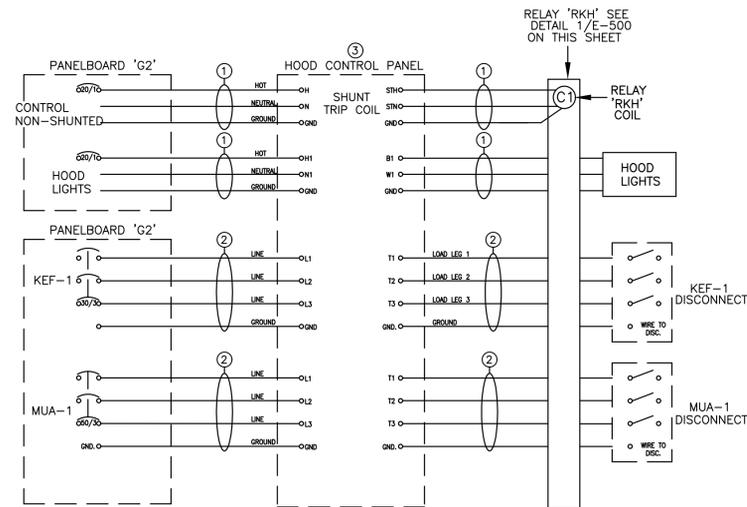- 1 1/2" CONDUIT WITH 2-#12 THHN. CU. CONDRS. AND 1-#12 CU. GND.
- 2 3/4" CONDUIT WITH 3-#8 THWN. CU. CONDRS. AND 1-#10 CU. GND.
- 3 CONTRACTOR MUST COORDINATE WITH MECHANICAL PLANS, KITCHEN HOOD DRAWINGS, AND KITCHEN HOOD INSTALLER FOR EXACT WIRING REQUIREMENTS BEFORE DOING ANY WORK. CONTRACTOR MUST MAKE CONNECTIONS TO ALL HOOD ACCESSORY ITEMS FROM CONTROL PANEL.

**2** KITCHEN HOOD CONTROL PANEL  
E5.0 NTS  
NOTE: KITCHEN HOOD CONTROL WIRING CONNECTION IS FOR REFERENCE AND GENERAL REQUIREMENTS ONLY. CONTRACTOR MUST COORDINATE WITH KITCHEN HOOD INSTALLER/MANUFACTURER FOR EXACT INTERCONNECTION REQUIREMENTS BEFORE DOING ANY WORK. CONTRACTOR MUST ENSURE A FULLY FUNCTIONAL KITCHEN HOOD AND FIRE SUPPRESSION SYSTEM. CONNECT FIRE SUPPRESSION SYSTEM TO THE FIRE ALARM SYSTEM.

**F.A. LEGEND**

- ☒ 15 STROBE, NUMBER DENOTES 'cd' RATING
- ☒ 15 HORN/STROBE, NUMBER DENOTES 'cd' RATING
- ☒ PULL STATION WITH STOPPER
- ☒ SMOKE DETECTOR
- ☒ H HEAT DETECTOR
- ☒ DUCT/SMOKE DETECTOR WITH REMOTE INDICATOR
- FARA FIRE ALARM REMOTE ENUNCIATOR
- FACP FIRE ALARM CONTROL PANEL WITH DIGITAL NOTIFIER
- TS DUCT SMOKE DETECTOR TEST SWITCH

**F.A. NOTES**

- FIRE ALARM INSTALLER TO INSTALL SYSTEM TO MEET ALL NATIONAL AND LOCAL FIRE CODES. INSTALLER TO SUBMIT TO ARCHITECT "AS BUILT"
- FIRE ALARM INSTALLER TO COORDINATE AND CONNECT SMOKE DETECTION SYSTEM TO A/C DUCT SYSTEM.
- FIRE ALARM INSTALLER CAN SUBSTITUTE FIRE ALARM FIXTURES FOR OTHERS OF EQUAL PERFORMANCE.
- F.A. INSTALLER MUST BE CERTIFIED BY THE STATE AND SUBMIT ALL REQUIRED PLANS AND DRAWINGS, F.A. SYSTEM CALCULATIONS AND ALL APPLICABLE SUBMITTALS TO THE GOVERNING AUTHORITIES TO OBTAIN A PERMIT.
- THE F.A. INSTALLER MUST BID ON A COMPLETE F.A. SYSTEM THAT CONFORMS TO ALL APPLICABLE CODES.
- FIRE ALARM PANEL MUST HAVE PHONE DIALER AND BE CONNECTED TO PHONE SYSTEM.
- F.A. INSTALLER MUST VISIT SITE TO BECOME FAMILIAR WITH EXISTING CONDITIONS BEFORE BIDDING ON THIS PROJECT.
- CONTRACTOR MUST VISIT SITE BEFORE BIDDING ON THIS PROJECT AND ALLOWED FOR ANY MODIFICATIONS OR ADDITIONS NEEDED TO BE DONE ON THE EXISTING FIRE ALARM PANEL TO ACCOMMODATE ALL NEW DEVICES IN THE NEW ADDITION. CONTRACTOR TO DETERMINE IF NEW FIRE ALARM CONTROL PANEL IS NEEDED AND INSTALL A FIRE ALARM CONTROL PANEL IF NEEDED. CONTRACTOR MUST MAKE ALL FINAL CONNECTION AND TEST THE SYSTEM IN THE PRESENCE OF SCHOOL PERSONNEL OR ENGINEER.
- VERIFY LOCATIONS OF ALL ELECTRICAL EQUIPMENT WITH OTHER TRADES TO AVOID CONFLICTS AND INTERFERENCES.
- CONTRACTOR TO INSTALL A PLYWOOD TELEPHONE BOARD. SEE SPECIAL SYSTEMS PLAN FOR REQUIREMENTS.
- CONTRACTOR TO COORDINATE NEW SERVICE WITH OWNER AND LOCAL UTILITY AS SOON AS CONTRACT IS LET.
- CONTRACTOR MUST VISIT SITE TO BECOME FAMILIAR WITH EXISTING CONDITIONS BEFORE BIDDING ON THIS PROJECT.
- ALL ELECTRICAL EQUIPMENT IN FIRE RATED ASSEMBLIES MUST BE INSTALLED SO THAT FIRE RATING IS NOT COMPROMISED. ELECTRICAL CONTRACTOR MUST INSTALL FIRE-STOPPING SEALS AND MATERIALS AS NECESSARY ON ALL PENETRATIONS MADE ON ALL FIRE RATED ASSEMBLIES TO MATCH FIRE RATING.
- BRANCH CIRCUIT NUMBERS ARE TO BE WRITTEN WITH BLACK INK MARKERS ON ALL COVERS OF ALL JUNCTION BOXES LOCATED ABOVE CEILING. MARKINGS MUST INDICATE THE PANEL AND CIRCUIT NUMBER OF CIRCUITS IN THAT BOX.
- MC CABLE IS NOT ALLOWED FOR ELECTRICAL INSTALLATIONS EXCEPT FOR LIGHT FIXTURE WHIPS.

**GENERAL NOTES:**

- ELECTRICAL INSTALLATION MUST FOLLOW ALL NATIONAL AND LOCAL ELECTRICAL CODES. INSTALLATION MUST CONFORM TO THE LOCAL POWER COMPANY'S SPECIFICATIONS.
- ELECTRICAL CONTRACTOR MUST COORDINATE AND VERIFY WITH MECHANICAL AND PLUMBING CONTRACTOR THE LOCATION AND ELECTRICAL REQUIREMENTS TO ALL A/C EQUIPMENT, MOTORS, PUMPS, T-STATS., INTERLOCKING WIRING, ETC.
- ALL MATERIALS SHALL BE IN ACCORDANCE WITH THE NATIONAL ELECTRICAL MANUFACTURERS ASSOCIATION AND SHALL BE LISTED BY THE U.L.
- ELECTRICAL CONTRACTOR MUST COORDINATE ALL POWER SERVICE ON THIS PROJECT. THE CONTRACTOR IS RESPONSIBLE FOR ALL FEES FOR TEMPORARY SERVICE.
- ELECTRICAL CONTRACTOR IS RESPONSIBLE FOR ALL PERMIT AND INSPECTION FEES REQUIRED BY THE GOVERNING BODIES.
- ELECTRICAL CONTRACTOR MUST COMPLY WITH THE LATEST A.D.A. REQUIREMENTS.
- MINIMUM SIZE CONDUCTORS SHALL BE #12 THW CU. UNLESS NOTED OR SIZED BY CODE.



**ALPHA ENGINEERING, INC.**  
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Architecture

108 SOUTH STANTON . THIRD FLOOR . EL PASO, TEXAS 79901 915.929.1827



DRAWN BY: A.P/A/E/E  
PROJECT NO: 2022-16  
ISSUED: SEPTEMBER 30, 2022

REVISION SCHEDULE:

NO.	DATE	DESCRIPTION

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**TORNILLO INDEPENDENT SCHOOL DISTRICT CAFETERIA CONVERSION**  
300 OIL MILL DR. | TORNILLO, TX 79853

SHEET TITLE:  
**ELECTRICAL DETAILS**

SCHEMATIC DESIGN

**E5.0**

# PLUMBING GENERAL NOTES

- COMPLY WITH ALL LOCAL, COUNTY, STATE, AND FEDERAL CODES, ORDINANCES, RULES AND REGULATIONS.
- COMPLY WITH ALL REQUIREMENTS OF THE SERVING AGENCIES, PAY ALL COSTS REQUIRED FOR METER INSTALLATIONS, SEWER TAPS, ETC.
- COMPLY WITH ALL REFERENCED COMMERCIAL STANDARDS, RULES, SPECIFICATIONS, ETC.
- WATER PIPING ABOVE GROUND USE TYPE "L" HARD DRAWN COPPER. WATER PIPING BELOW BUILDING SLAB USE TYPE "K" HARD DRAWN COPPER PIPE AND FITTINGS
- WATER PIPING 5' BEYOND BUILDING 4" AND LARGER USE AWWA C900 CLASS 150 PIPE. WATER PIPING 5' BEYOND BUILDING 3.0" AND SMALLER USE TYPE "K" HARD DRAWN COPPER
- ALL WATER PIPING USED FOR DRINKING PURPOSES SHALL BE SOLDER WITH LEAD-FREE.
- WASTE AND VENT PIPING BELOW AND ABOVE GRADE USE SOLID CORE SCHEDULE 40 PVC.
- INDOOR/OUTDOOR CONDENSATE PIPING SHALL BE TYPE "L" COPPER.
- ALL ABOVE GRADE GAS PIPING SHALL BE SCHEDULE 40 BLACK STEEL. GAS PIPING BELOW GRADE SHALL HAVE A PROTECTIVE COATING (EX. X-TRU-COAT). POLYETHYLENE PIPING BELOW GRADE AND 5' BEYOND BUILDING IS PERMITTED.
- INSTALL DIELECTRIC FITTING BETWEEN FERROUS AND NON-FERROUS MATERIALS.
- RELIEF DRAIN PIPING FOR WATER HEATERS TO BE RUN TO APPROVED RECEPTACLES.
- CONTRACTOR TO VERIFY LOCATION OF EXISTING WATER AND SEWER MAINS AND POINTS OF CONNECTION.
- CONTRACTOR TO INSTALL SHUT-OFF VALVES ON EACH WATER SUPPLY AT EACH PLUMBING FIXTURE AND ALL EQUIPMENT.
- INSTALL WALL CLEANOUTS AT EACH LAVATORY, URINAL, SINK AND WATER COOLER.
- INSULATE ALL HOT AND COLD WATER PIPING WITH 1" FIBERGLASS INSULATION FOR PIPES UP 1-1/2" IN DIAMETER. INSULATE WITH 2" FIBERGLASS FOR PIPES OVER 1-1/2".
- ALL PIPING EXPOSED TO WEATHER SHALL BE PAINTED AND COATED WITH AN APPROVED PROTECTIVE COATING FOR CORROSION CONTROL.
- ALL PIPING IS TO BE HUNG AND ANCHORED BY APPROVED MEANS AND INTERVALS AS PER APPLICABLE CODE.
- CONTRACTOR IS TO VERIFY THAT FALL OF THE SEWER LINE WILL MEET INVERT AT POINT OF CONNECTION BEFORE INSTALLING PIPING.
- INSULATE CONDENSATE LINES ABOVE GRADE WITH 1" FIBERGLASS INSULATION.
- ALL UNDERGROUND WATER LINES TO BE BURIED BELOW FROSTLINE, MIN. 24" OR GREATER, AS DICTATED BY LOCAL CODES.
- ALL INDIRECT WASTE LINES TO BE AIR GAPPED OVER FLOOR SINKS AND FLOOR DRAINS.
- ALL WATER HEATERS SHALL COMPLY WITH ASHRAE 90.1 STANDARD LATEST EDITION. AND THE CURRENT TEXAS LOW NOX STANDARDS.
- BUILDING SHALL HAVE AN APPROVED BACKFLOW PREVENTION DEVICE OF REDUCED PRESSURE TYPE (E.P.A. AND COUNTY APPROVED).
- EXPOSED HOT WATER AND DRAIN PIPING LOCATED BENEATH HANDICAPPED ACCESSIBLE LAVATORIES SHALL BE INSULATED, AS SPECIFIED.
- WATER METER, BACKFLOW PREVENTERS AND MASTER SHUT-OFF VALVES MOUNTED INSIDE VALVE OR YARD BOXES SHALL BE AND COVERED WITH ALUMINUM JACKET INSULATION TO PREVENT FREEZING.
- FIRE SEAL ALL PENETRATIONS OF RATED WALLS PER APPLICABLE U.L. RATED SYSTEM.

## PLUMBING SYMBOL LEGEND

SYMBOL	DESCRIPTION	SYMBOL	DESCRIPTION
— EF —	EXISTING FIRE PROTECTION	VTR	VENT THRU ROOF
— F —	FIRE PROTECTION	DGCO	DOUBLE GRADE CLEANOUT
— — — —	DOMESTIC COLD WATER LINE	GCO	GRADE CLEANOUT
— — — —	DOMESTIC HOT WATER LINE	— —	CHECK VALVE
— — — —	HOT WATER SUPPLY	— —	PLUG VALVE
— — — —	VENT PIPING	— —	BALANCING VALVE WITH MEMORY STOP
EV	EXISTING VENT	— —	RELIEF VALVE
ES	NEW SANITARY SEWER LINE	— —	PRESSURE REDUCING VALVE
EG	EXISTING SOIL LINE	— —	BUTTERFLY VALVE
G	NEW GAS LINE	— —	NEEDLE VALVE
EG	EXISTING GAS LINE	— —	BALL VALVE
D	DRAIN LINE	— —	STRAINER
CD	CONDENSATE DRAIN	— —	UNION
○	KEYED NOTES	— —	FLANGED CONNECTION
FCO	FLOOR CLEANOUT	— —	THERMOMETER
WCO	WALL CLEANOUT	— —	GAUGE
○	NEW TO EXISTING CONNECTION	— —	REDUCER
RDL	ROOF DRAIN LEADER	— —	VALVE IN RISE
OFL	OVER FLOW LEADER	— —	PIPE ELBOW DOWN
OFD	OVERFLOW DRAIN	— —	

## MINIMUM PIPE MATERIAL SCHEDULE

SERVICE TYPE	LOCATION	MATERIAL REQUIRED	COMMENTS
SANITARY WASTE, VENT	BELOW GRADE 5'-0" OUTSIDE BUILDING FOOTPRINT	SCHEDULE 40 PVC W/ SOLVENT WELDED JOINTS	SEE MATERIAL SUBSTITUTION NOTES
	BELOW GRADE WITHIN 5'-0" BUILDING FOOTPRINT	SCHEDULE 40 PVC W/ SOLVENT WELDED JOINTS	SEE MATERIAL SUBSTITUTION NOTES
	ABOVE GRADE WITHIN BUILDING	SCHEDULE 40 PVC W/ SOLVENT WELDED JOINTS	SEE MATERIAL SUBSTITUTION NOTES
DOMESTIC WATER FOR COLD HOT AND CIRCULATION	EXPOSED DRAINS WITHIN MECHANICAL ROOMS AND KITCHENS	HARD DRAWN TYPE "K" COPPER. KITCHEN LINES SHALL BE PAINTED SILVER	
	BELOW GRADE OUTSIDE BUILDING FOOTPRINT	COPPER TYPE "K" HARD DRAWN	
HYDRONIC PIPING	BELOW GRADE INSIDE BUILDING FOOTPRINT	COPPER TUBING TYPE "K" SOFT DRAWN	NO JOINTS BELOW SLAB
	ABOVE GRADE/SLAB WITHIN BUILDING	COPPER TYPE "L" HARD DRAWN	
CONDENSATE & EVAPORATIVE COOLER DRAINS	THROUGH OUT SYSTEM	COPPER TYPE "L"	PRO PRESS FITTINGS
PIPE MATERIAL SUBSTITUTION NOTES:		SCHEDULE 40 PVC W/ SOLVENT WELDED JOINTS	SIMILAR TO WATER APPLICATIONS
		INSULATED WITH 1" FIBERGLASS INSULATION	
NOTE: ALL PVC PIPE SHALL BE SOLID CORE, NO EXCEPTIONS.			
SUBSTITUTIONS NOTICE: INSTALLATION OF MATERIALS OTHER THAN THOSE LISTED ABOVE SHALL NOT BE ALLOWED UNLESS APPROVED BY THIS OFFICE IN WRITING AND WHEN PERMITTED BY LOCAL AUTHORITIES.			
INSULATION REQUIREMENTS: ALL COLD WATER AND CONDENSATE PIPING INSTALLED WITHIN BUILDING SHELL SHALL BE INSULATED WITH A MINIMUM 1" FIBERGLASS THICKNESS. ALL DOMESTIC HOT WATER PIPING SHALL BE INSULATED WITH 1" THICK MATERIAL RATED AT 0.24 BTUH / INCH / SQ.FT. / DEG. F TO MEET OR EXCEED ENERGY CONSERVATION CODE. APPROVED INSULATION MATERIALS SHALL BE: SLEEVED FIBERGLASS MATERIAL SEALED VAPOR TIGHT IN ACCORDANCE TO APPROVED INDUSTRY STANDARDS AND PRACTICES. SEE SPECIFICATIONS FOR OTHER APPROVED MATERIAL TYPES. THIS SCHEDULE IS PROVIDED AS MINIMUM INSULATION REQUIREMENTS ONLY AND SPECIFICATIONS SHALL SUPERSEDE THIS SCHEDULE WHERE SPECIFICATIONS CALL FOR GREATER INSULATION MATERIALS AND/OR INSTALLATION METHODS.			


## HANGER SPACING SCHEDULE

PIPING MATERIAL	MAXIMUM HORIZONTAL SPACING (feet)	MAXIMUM VERTICAL SPACING (feet)
Acrylonitrile butadiene styrene (ABS) pipe	4	10b
Aluminum tubing	10	15
Brass pipe	10	10
Cast-iron pipe	5a	15
Chlorinated polyvinyl chloride (CPVC) pipe and tubing, 1" and smaller	3	10b
Chlorinated polyvinyl chloride (CPVC) pipe and tubing, 1-1/4" and larger	4	10b
Copper or copper-alloy pipe	12	10
Copper or copper-alloy tubing, 1-1/4 -inch diameter and smaller	6	10
Copper or copper-alloy tubing, 1-1/2 -inch diameter and larger	10	10
Cross-linked polyethylene (PEX) pipe	2.67 (32 inches)	10b
Cross-linked polyethylene/ aluminum/cross-linked polyethylene (PEX-AL-PEX) pipe	2.67 (32 inches)	4
Lead pipe	Continuous	4
Polyethylene/aluminum/ polyethylene (PE-AL-PE) pipe	2.67 (32 inches)	4
Polyethylene of raised temperature (PE-RT) pipe	2.67 (32 inches)	10b
Polypropylene (PP) pipe or tubing 1 inch and smaller	2.67 (32 inches)	10b
Polypropylene (PP) pipe or tubing, 1-1/4 inches and larger	4	10b
Polyvinyl chloride (PVC) pipe	4	10b
Stainless steel drainage systems	10	10b
Steel pipe	12	15

For SI: 1 inch = 25.4 mm, 1 foot = 304.8 mm.

a. The maximum horizontal spacing of cast-iron pipe hangers shall be increased to 10 feet where 10-foot lengths of pipe are installed.

b. For sizes 2 inches and smaller, a guide shall be installed midway between required vertical supports. Such guides shall prevent pipe movement in a direction perpendicular to the axis of the pipe.

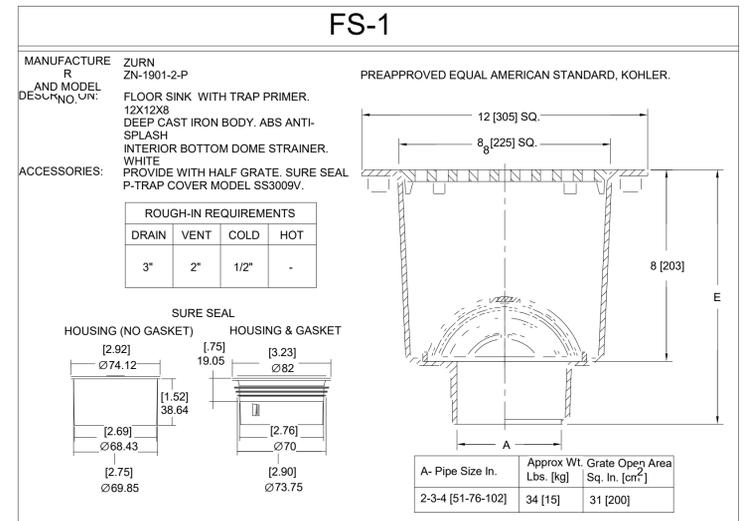

## MINIMUM PIPE INSULATION THICKNESS SCHEDULE



FLUID OPERATING TEMPERATURE RANGE AND USAGE (%143F)	INSULATION CONDUCTIVITY		NOMINAL PIPE OR TUBE SIZE (inches)				
	Conductivity Btu · in./h · ft <sup>2</sup> · F/ft	Mean Rating Temperature, F	<1	1 TO < 1-1/2	1-1/2" TO < 4	1 TO < 8	≥ 8
> 350	0.32 – 0.34	250	4.5	5.0	5.0	5.0	5.0
251 – 350	0.29 – 0.32	200	3.0	4.0	4.5	4.5	4.5
201 – 250	0.27 – 0.30	150	2.5	2.5	2.5	3.0	3.0
141 – 200	0.25 – 0.29	125	1.5	1.5	2.0	2.0	2.0
105 – 140	0.21 – 0.28	100	1.0	1.0	1.5	1.5	1.5
40 – 60	0.21 – 0.27	75	0.5	0.5	1.0	1.0	1.0
< 40	0.20 – 0.26	50	0.5	1.0	1.0	1.0	1.5

For SI: 1 inch = 25.4 mm, °C = [(°F) - 32]/1.8.

a. For piping smaller than 1-1/2 inches and located in partitions within conditioned spaces, reduction of these thicknesses by 1 inch shall be permitted (before thickness adjustment required in footnote b) but not to a thickness less than 1 inch.

b. For insulation outside the stated conductivity range, the minimum thickness (T) shall be determined as follows:  
 $T = r(1 + 1/r)k - 1$   
 where:  
 T = minimum insulation thickness,  
 r = actual outside radius of pipe,  
 l = insulation thickness listed in the table for applicable fluid temperature and pipe size,  
 k = conductivity of alternate material at mean rating temperature indicated for the applicable fluid temperature (Btu · in/h · ft<sup>2</sup> · °F) and  
 k = the upper value of the conductivity range listed in the table for the applicable fluid temperature.

c. For direct-buried heating and hot water system piping, reduction of these thicknesses by 1-1/2 inches (38 mm) shall be permitted (before thickness adjustment required in footnote b) but not to thicknesses less than 1 inch (25 mm).

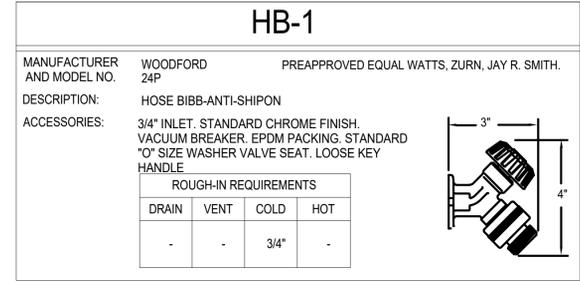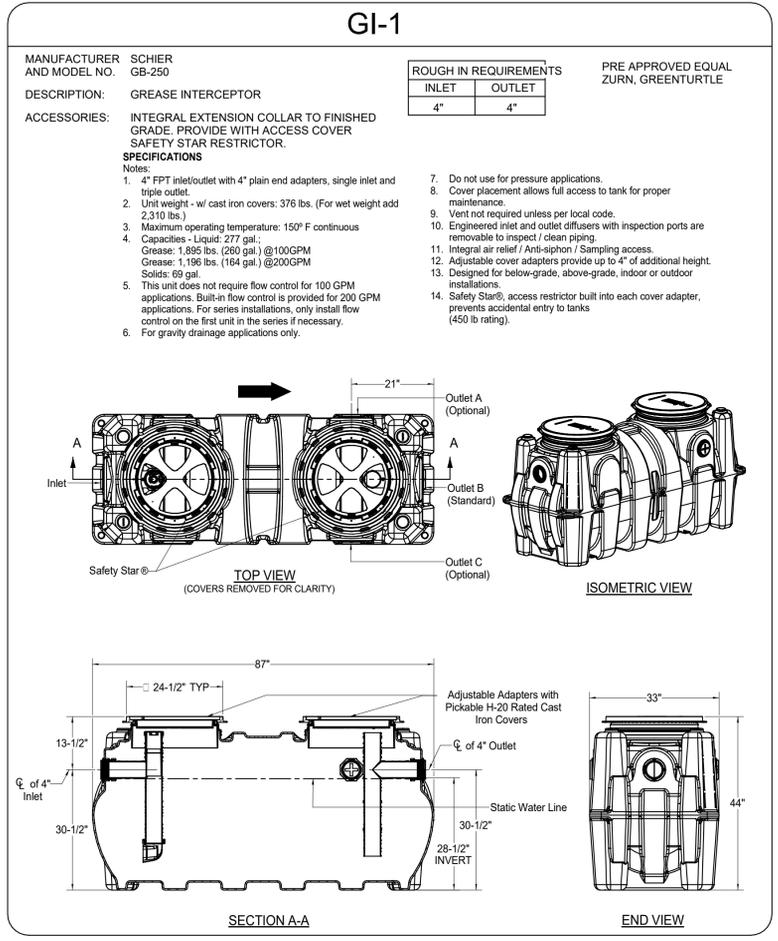

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## Architecture

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DRAWN BY: AEG  
PROJECT NO: 2022-16  
ISSUED: 10/24/2022

REVISION SCHEDULE:

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# TORNILLO INDEPENDENT SCHOOL DISTRICT CAFETERIA CONVERSION

300 OIL MILL DR. | TORNILLO, TX 79853

## P-100

### PLUMBING LEGEND, GENERAL NOTES & SCHEDULES


Project Status

L-1

MANUFACTURER AND MODEL NO. ZURN : Z5368 531.4.87.59.6 PREAPPROVED EQUAL AMERICAN STANDARD, KOHLER.

DESCRIPTION: VITREOUS CHINA WALL HUNG LAVATORY  
 ACCESSORIES: FIXTURE: Z5368 20"x18" WALL HUNG LAVATORY, ZURN Z831B4-CT XL FREE POLISHED CHROME PLATED CAST BRASS FAUCET, Z8746-PC, OFFSET WHEELCHAIR GRID DRAIN, Z8711-PC 1-1/4" X 1-1/2" CAST BRASS SWIVEL P-TRAP WITH CLEANOUT, ZURN ZH823LR-8862-12-PC, SUPPLY KIT LAVATORY, Z8946-3-NT ADA COMBINATION TRAP AND SUPPLY WRAP PROTECTOR KIT, ZURN CONCEALED ARM WALL CARRIER Z1231.

ROUGH-IN REQUIREMENTS			
DRAIN	VENT	COLD	HOT
2"	1-1/2"	1/2"	1/2"

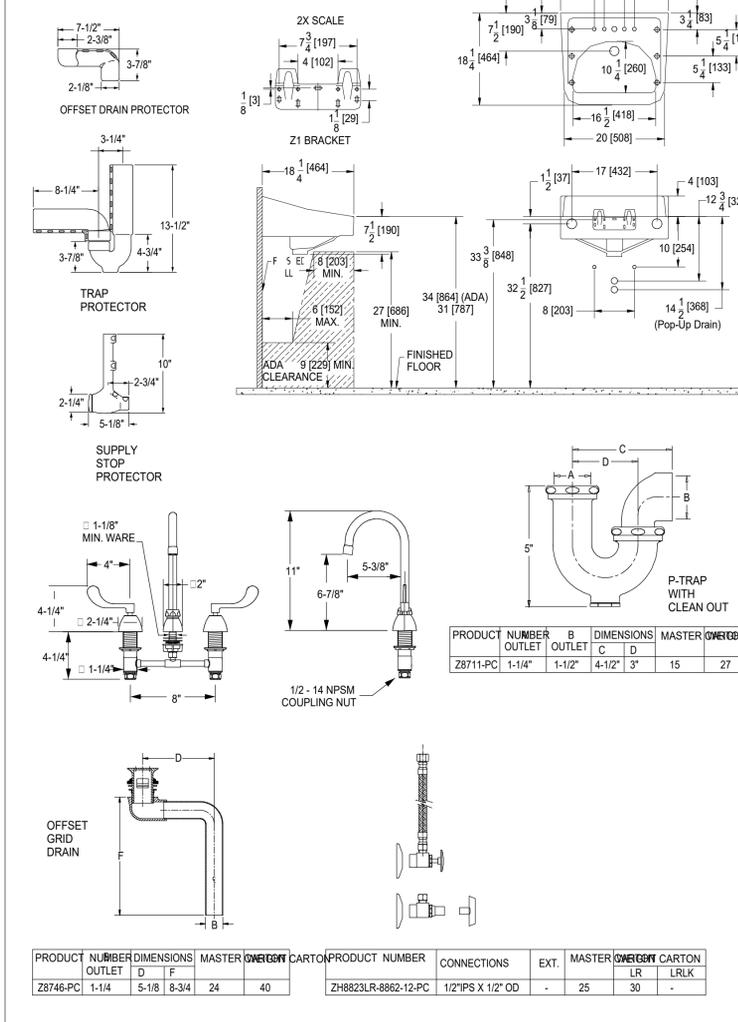


MS-1

MANUFACTURER AND MODEL NO. FIAT TSB100 PREAPPROVED EQUAL AMERICAN STANDARD, KOHLER.

DESCRIPTION: MOP SINK-24"x24" TERRAZO 12" DEPTH, TAN TERRAZO SURFACE GROUND AND POLISH.  
 ACCESSORIES: T&S B-665-BSTR FAUCET, B-0653 HOSE AND BRACKET, B-0653 MOP HANGER WITH STAINLESS STEEL CAPS ON ALL CURBS, INTEGRAL TILTING FLANGES, STAINLESS STEEL STRAINER # 1453 BB.


ROUGH-IN REQUIREMENTS			
DRAIN	VENT	COLD	HOT
3"	2"	3/4"	3/4"

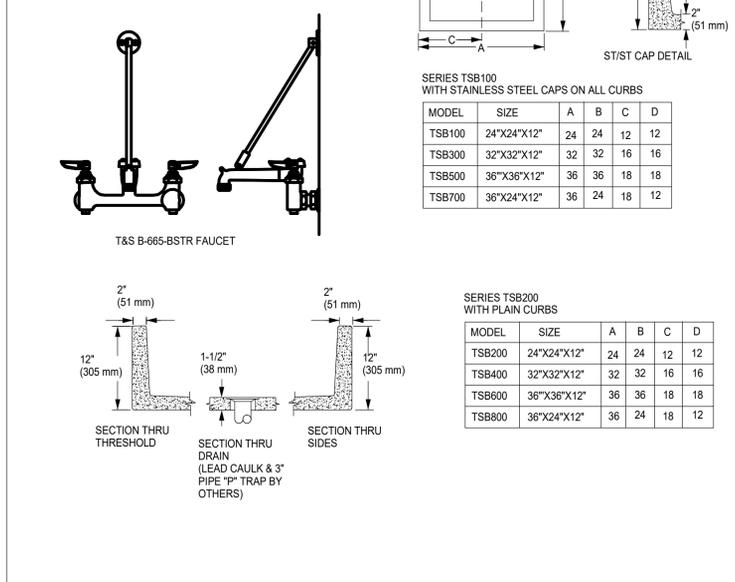

TD-1

MANUFACTURER AND MODEL NO. ADVANCE TABCO FTG-1248


DESCRIPTION: 48" LONG WASTE RECEPTACLE  
 ACCESSORIES: FTG SERIES GRATING

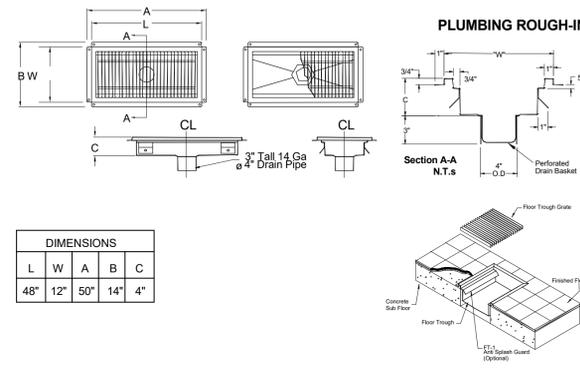

WCO

MANUFACTURER AND MODEL NO. ZURN Z-1446 PREAPPROVED EQUAL WATTS, JAY R. SMITH, WADE.


DESCRIPTION: WALL CLEANOUT WITH ROUND ACCESS COVER.  
 ACCESSORIES: DURA-COATED CAST IRON BODY WITH POLISHED STAINLESS STEEL COVER, VANDAL PROOF SCREWS, BRASS PLUG.

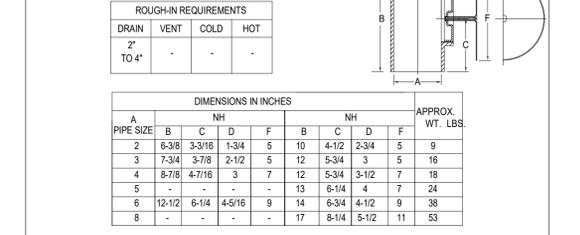

RP-1

MANUFACTURER AND MODEL NO. TACO IL112 PREAPPROVED EQUAL B & G. ARMSTRONG, PACO.


DESCRIPTION: RECIRCULATING PUMP  
 ACCESSORIES: CAPACITY OF 5 GPM AT 20 FT OF HEAD, CONTROLLED WITH AN AQUASTAT AND TIMER, 3/4" FLANGE COMPANION.

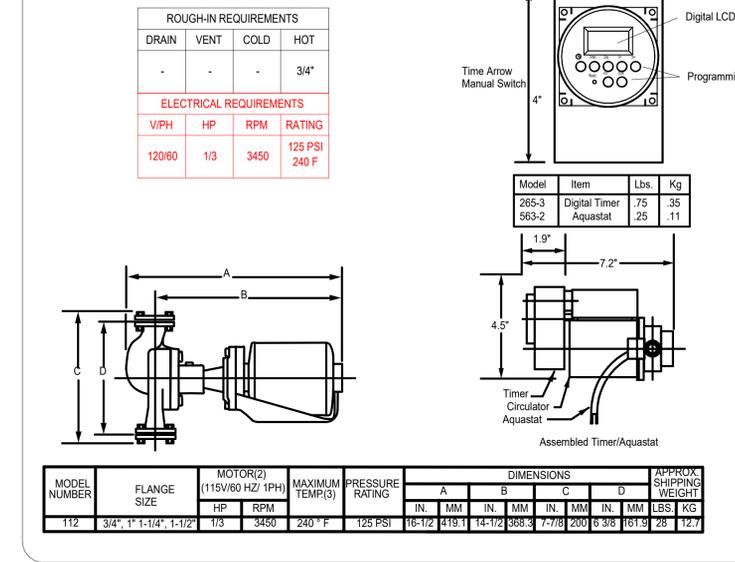

WHA

MANUFACTURER AND MODEL NO. ZURN Z-1250 XL

DESCRIPTION: WATER HAMMER ARRESTOR.  
 ACCESSORIES: LEAD FREE, COPPER TUBE TYPE L, LOW LEAD BRASS TAIL PIECE AND PISTON, BUNA NITRILE O-RING

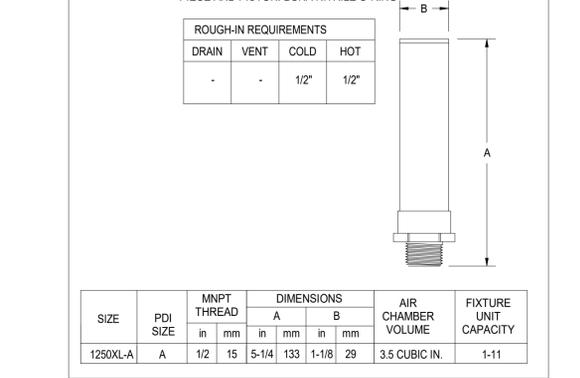

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 PROJECT NO: 2022-16  
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 SHEET TITLE: PLUMBING SCHEDULES & SCHEMATIC

Project Status

P-101


S-1

MANUFACTURER AND MODEL NO. BK RESOURCES - OR APPROVED EQUAL 14X10 HAND SINK (INT DIMENSION) PREAPPROVED EQUAL JUST, ELKAY, ADVANCED TABCO

DESCRIPTION: WALL MOUNTED SINGLE COMP SINK WITH SIDE SPLASHES, GOOSENECK FAUCET.

ACCESSORIES: BKF-W-3G-G FAUCET, STRAINER, CENTER DRAIN LOCATION, QUARTER TURN ANGLE STOPS, STAINLESS STEEL FLEXIBLE HOSE CONNECTORS 1/2" X 3/8", ZURN ZB946-3-NT COMBINATION KIT ONE TRAP, TWO SUPPLY STOPS.

ROUGH-IN REQUIREMENTS			
DRAIN	VENT	COLD	HOT
2"	1-1/2"	1/2"	1/2"

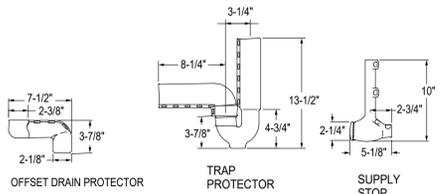


**BK** 14" x 10" Hand Sinks w/ Side Splash  
Stainless Steel Hand Sinks



**Features:**  
• Wall Mounting Hardware Included  
• Drain Included  
• Accommodates 4" O.C. Faucets  
• Marine Edge

**Options:**  
• Upgraded Faucets  
• Other Plumbing Accessories - Call For Details

Part Number	Unit Size (w x d)	Bowl Dim. (l x w x d)	Faucet / Spout Mounting	Side Splash	Included Faucet	Drain Size	Product Weight (lbs)
BKHS-W-1410-SS	17" x 15 1/2"	14" x 10" x 5"	4" O.C. Splash	Dual	-	1 7/8"	12.50
BKHS-W-1410-RS	17" x 15 1/2"	14" x 10" x 5"	4" O.C. Splash	Right	-	1 7/8"	11.00
BKHS-W-1410-LS	17" x 15 1/2"	14" x 10" x 5"	4" O.C. Splash	Left	-	1 7/8"	11.00
<b>BKHS-W-1410-SS-P-G</b>	<b>17" x 15 1/2"</b>	<b>14" x 10" x 5"</b>	<b>4" O.C. Splash</b>	<b>Dual</b>	<b>BKF-W-3G-G</b>	<b>1 7/8"</b>	<b>13.30</b>

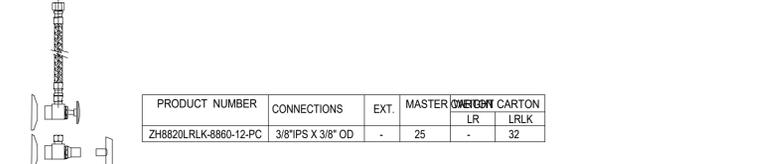

S-2

MANUFACTURER AND MODEL NO. BK RESOURCES BKS-224-14-24TS PREAPPROVED EQUAL JUST, ELKAY, ADVANCED TABCO


DESCRIPTION: 2 COMPARTMENT SINK, 18 GAUGE TYPE 304 NICKEL BEARING STAINLESS STEEL, LEFT AND RIGHT DRAIN BOARD.

ACCESSORIES: PRE RINSE UNITS AND FAUCETS MODEL T&S B-0133-B AND B-0156 ADD ON FAUCET, THREE NICKLE PLATED CAST TWIST LEVER BASKET STRAINER WITH MATCHING BASKET, PROVIDE WITH COMBO DRAIN LINE THAT WILL DISCHARGE INDIRECTLY OVER FLOOR SINK. PROVIDE QUARTER TURN LEAD FREE HEAVY DUTY ANGLE STOPS AND FLEXIBLE HOSE LINES.

ROUGH-IN REQUIREMENTS			
DRAIN	VENT	COLD	HOT
2"	1-1/2"	3/4"	3/4"



PART NUMBER	UNITX SIZE (l x w)	BOWL DIM. (l x w x d)	SETS OF HOLES	DRAINBOARD SIZE	LEGS	PRODUCT WEIGHT (lbs)
BKS-224-14-24TS	96" X 29-13/16"	24" X 24" X 14"	1	(2) - 24"	STAINLESS STEEL W/BRACING	105

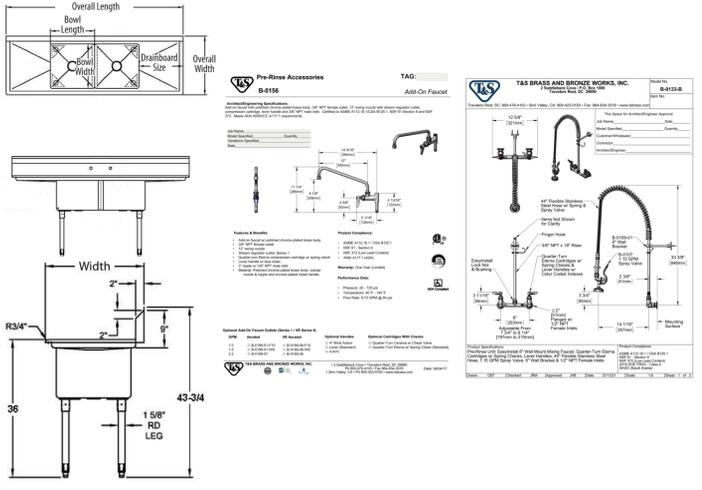


S-3

MANUFACTURER AND MODEL NO. BK RESOURCES BKS-3-1620-14-18TS PREAPPROVED EQUAL JUST, ELKAY, ADVANCED TABCO

DESCRIPTION: 3 COMPARTMENT SINK, 18 GAUGE TYPE 304 NICKEL BEARING STAINLESS STEEL, LEFT AND RIGHT DRAIN BOARD.

ACCESSORIES: PRE RINSE UNITS AND FAUCETS MODEL T&S B-0133-B AND B-0156 ADD ON FAUCET, THREE NICKLE PLATED CAST TWIST LEVER BASKET STRAINER WITH MATCHING BASKET, PROVIDE WITH COMBO DRAIN LINE THAT WILL DISCHARGE INDIRECTLY OVER FLOOR SINK. PROVIDE QUARTER TURN LEAD FREE HEAVY DUTY ANGLE STOPS AND FLEXIBLE HOSE LINES.

ROUGH-IN REQUIREMENTS			
DRAIN	VENT	COLD	HOT
2"	1-1/2"	3/4"	3/4"

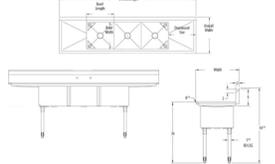

**BK** Three Compartment - Double Drainboard  
Stainless Steel Compartment Sinks



**Features:**  
• 1/4" Pitched Drainboards To Ensure Proper Drainage  
• 1 1/2" Rounded Front and Side Edges  
• Accommodates 6" On Center Faucets  
• Drains Included  
• 9" Backsplash

**Options:**  
• Chrome-Plated Units & Faucets  
• Lever Drains  
• Upgraded Buller Feet  
• Slant Back Shelf (BK-SSH)  
• End Splash (BKS-RES)  
• S/S Basket Drain (BKOR-3-304)

Part Number	Unit Size (l x w)	Bowl Dim. (l x w x d)	Sets of Faucet Holes	Drainboard Size	Legs	Product Weight (lbs)
BKS-3-1416-12-12T	66" x 21 1/2"	14" x 16" x 12"	1	(2) - 12"	Galvanized	59.00
BKS-3-1416-12-12TS	66" x 21 1/2"	14" x 16" x 12"	1	(2) - 12"	Stainless Steel w/ End Bracing	68.00
BKS-3-15-14-15T	75" x 20 1/2"	15" x 15" x 14"	1	(2) - 15"	Galvanized	67.00
BKS-3-15-14-15TS	75" x 20 1/2"	15" x 15" x 14"	1	(2) - 15"	Stainless Steel w/ End Bracing	76.50
BKS-3-1620-12-18T	84" x 25 1/2"	16" x 20" x 12"	1	(2) - 18"	Galvanized	85.00
BKS-3-1620-12-18TS	84" x 25 1/2"	16" x 20" x 12"	1	(2) - 18"	Stainless Steel w/ End Bracing	94.00
BKS-3-1620-14-18T	84" x 25 1/2"	16" x 20" x 14"	1	(2) - 18"	Galvanized	90.00
<b>BKS-3-1620-14-18TS</b>	<b>84" x 25 1/2"</b>	<b>16" x 20" x 14"</b>	<b>1</b>	<b>(2) - 18"</b>	<b>Stainless Steel w/ End Bracing</b>	<b>99.00</b>

WH-1


MANUFACTURER AND MODEL NO. AO SMIT BTH-400 Mxi

DESCRIPTION: 119 GALLON CAPACITY GAS FIRED WATER HEATER


ACCESSORIES: 399,900 BTUH INPUT, FACTORY INSTALLED POWER CORD, CONCENTRIC VENT KIT, NEUTRALIZER KIT, 3/4" T&P RELIEF VALVE, PROVIDE WITH PIPE COVER ISOLATION VALVE KITS, 2 GALLON ZURN EXPANSION TANK.

ROUGH IN REQUIREMENTS		
COLD	HOT	DRAIN
1-1/2"	1-1/2"	3/4"

ELECTRICAL		
V	F	A
120 V	60 Hz	5.0 A

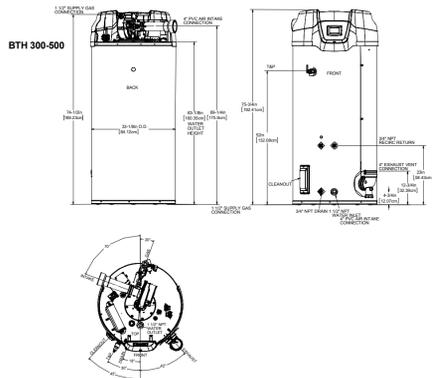

Model Number	Approx. Capacity	Dimensions											lb/kg	Approx. Shipping ASME
		A	B	C	D	E	F	G	H	I	J			
BTH-400(A)	119 Gallons / 450.90 Liters	75.3/4	52	33.1/8	4.3/4	4.3/4	63.1/8	12.3/4	69.1/4	74.1/2	23	55	855	

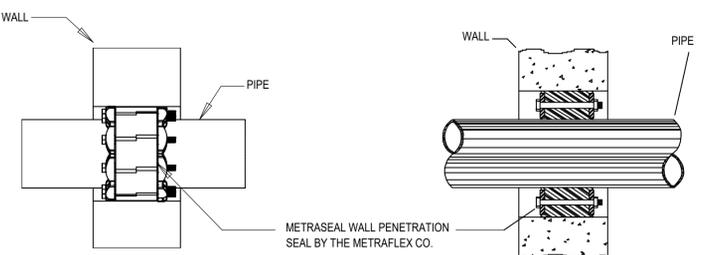


TYPE	SEAL MATERIAL	PRESSURE PLATES	BOLTS & NUTS	TEMPERATURE RANGE (°F)	APPLICATIONS*
E	EPDM Black	GLASS REINFORCED PLASTIC	STEEL zinc dichromate	-40 to +250	Suitable for most applications in water, both above ground and direct burial. Provides electrical insulation where cathodic protection is required.
ES	EPDM Black	GLASS REINFORCED PLASTIC	STAINLESS STEEL (18-8)	-40 to +250	Suitable for environments where the corrosion resistance of stainless steel hardware is required.
P	NITRILE	GLASS REINFORCED PLASTIC	STEEL zinc dichromate	-40 to +210	Resistant to most hydrocarbons, oil, gas, jet fuel, and many solvents.
PS	NITRILE	GLASS REINFORCED PLASTIC	STAINLESS STEEL (18-8)	-40 to +210	Same as above but with corrosion resistance of stainless steel hardware.
HT	Silicone	STEEL ZINC DICHROMATE	STEEL zinc dichromate	-40 to +400	High temperature applications.

1 PIPE THRU EXTERIOR WALL-METRAFLEX  
P-102 N.T.S.


**Countryman & Co.**  
Architecture  
108 SOUTH STANTON . THIRD FLOOR . EL PASO, TEXAS 79901 915.919.1827




THE SEAL APPEARING ON THIS DOCUMENT WAS AUTHORIZED BY JORGE A. SILVA, P.E. R9142 ON OCTOBER 22, 2022.

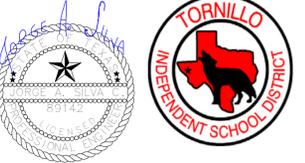


HANGER ROD SCHEDULE			
PIPE SIZE	ROD SIZE	PIPE SIZE	ROD SIZE
UP TO 2"	3/8" DIA	4" THRU 6"	5/8" DIA.
2-1/2" TO 3"	1/2" DIA	6" THRU 12"	7/8" DIA.

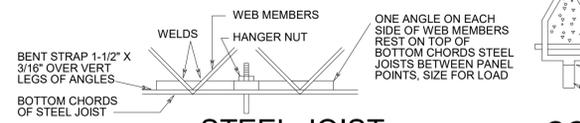


STEEL JOIST ANCHOR TYPES - WHEN NOT SPECIFIED BY STRUCTURAL

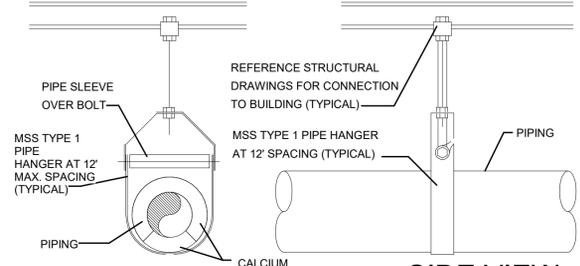

INDIVIDUAL PIPE SUPPORT

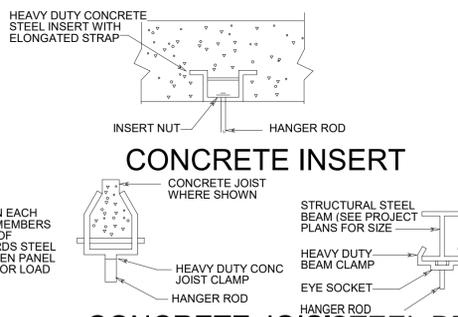



CONCRETE JOIST STEEL BEAM MULTIPLE TRAPEZE PIPE SUPPORT

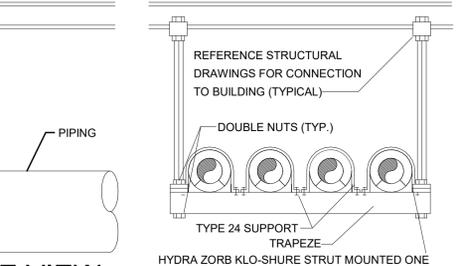

MULTIPLE TRAPEZE PIPE SUPPORT

2 PIPE HANGER SCHEMATICS  
P-102 N.T.S.

NO.	DATE	DESCRIPTION

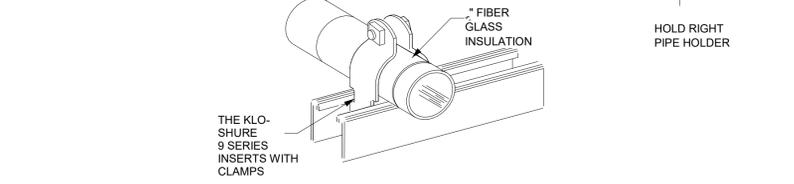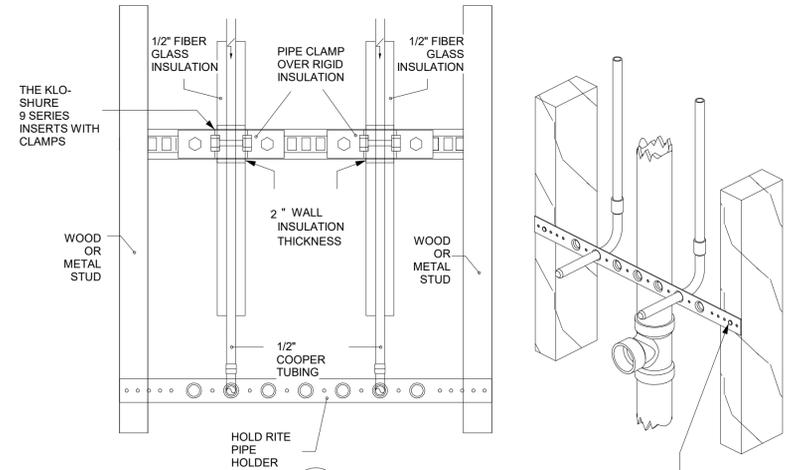


3 LAVATORY PIPING WALL SUPPORT SCHEMATIC  
P-102 N.T.S.

**TORNILLO INDEPENDENT SCHOOL DISTRICT CAFETERIA CONVERSION**  
300 OIL MILL DR. | TORNILLO, TX 79853  
SHEET TITLE: **PLUMBING SCHEDULES & SCHEMATIC**


Project Status

P-102


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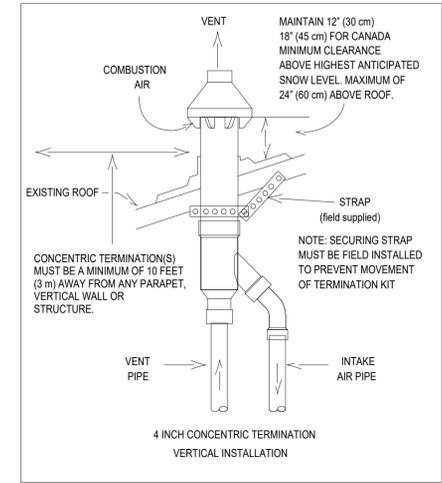
1 ROOF GAS PIPE SUPPORT & CONNECTION SCHEMATIC  
P-103 N.T.S.

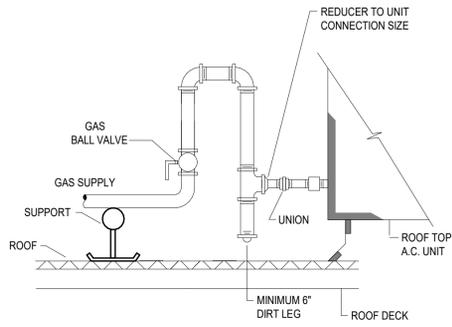


2 CONDENSATE DRAIN TRAP SCHEMATIC  
P-103 N.T.S.

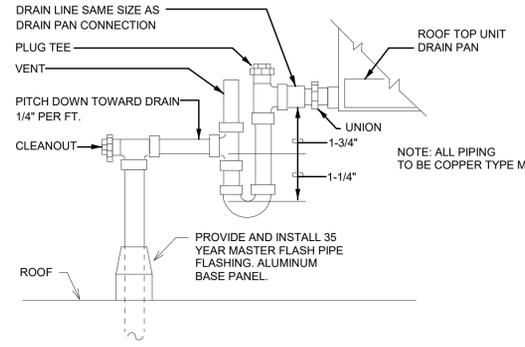

3 CONDENSATE KIT INSTALLATION SCHEMATIC  
P-103 N.T.S.

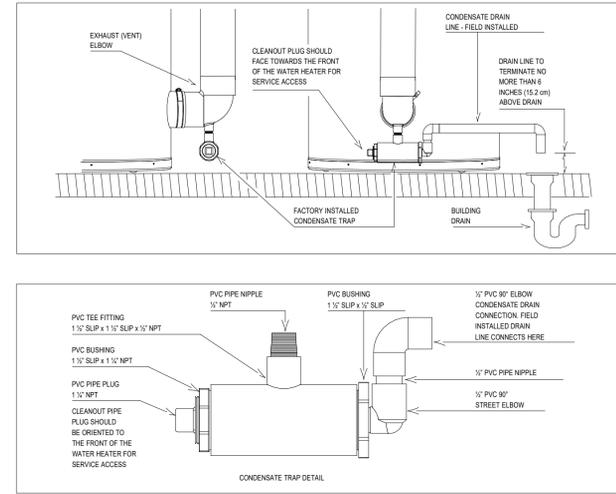

4 CONCENTRIC TERMINATION VERTICAL INSTALLATION SCHEMATIC.  
P-103 N.T.S.

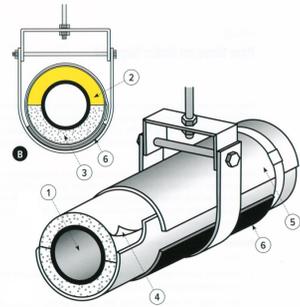


Hot and cold piping insulated with a low density pipe insulation often requires an insert of high density insulation at points of support to prevent the weight of the pipe from crushing the insulation. These inserts may be any one of the high density insulations used for high temperature installations such as calcium silicate and perlite, or anyone of the various cellular and foam insulations used on cold applications. Clevis hangers should be sized appropriately to allow clearance for the specified thickness of insulation. Shields may or may not be supplied by the insulation contractor. The illustration shows application methods using inserts on cold piping. The use of these inserts is also applicable on hot piping.

Detail B - 1800 high density insulation insert.

Materials: High density pipe insulation section and shield.


1. Pipe.
2. Insulation (type specified).
3. High density insulation insert.
4. Factory-applied vapor-retarder jacket securing two insulation sections together (cold application).
5. Jacketing (field-applied metal shown).
6. Metal shield.
7. For low temperature applications the insert should be embedded in a vapor retarder mastic.

5 CLEVIS HANGER- HIGH DENSITY INSERTS SCHEMATIC  
P-103 N.T.S.

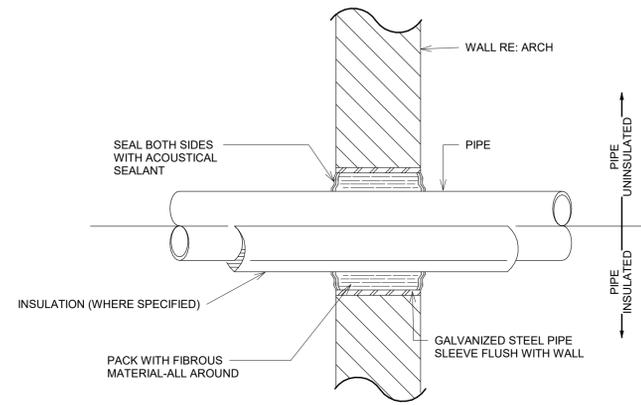


NOTES:  
1. WHERE PIPING IS EXPOSED TO VIEW PROVIDE WITH ESCUTCHEON.


6 DETAIL - PIPE PENETRATION THRU NON-RATED WALL  
P-103 N.T.S.

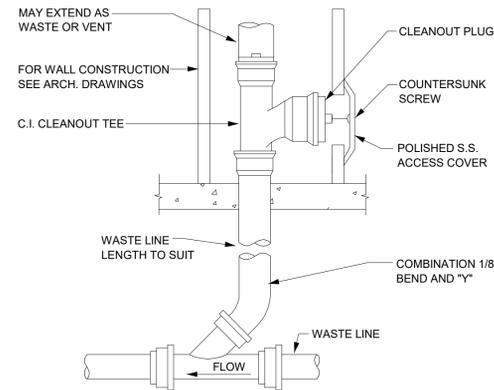


7 WALL CLEANOUT SCHEMATIC  
P-103 N.T.S.

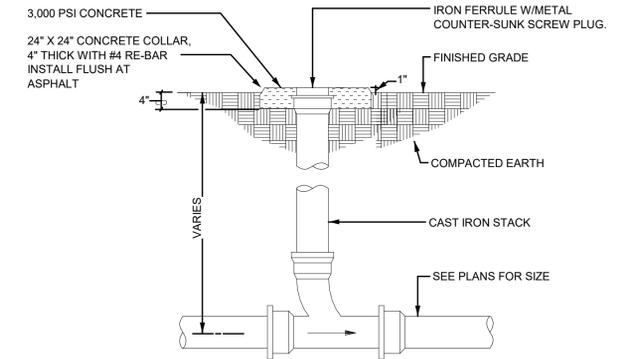

8 CLEANOUT TO GRADE DETAIL  
P-103 N.T.S.

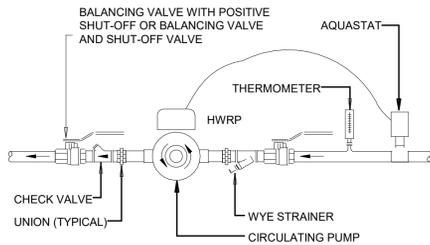

9 RECIRCULATING HOT WATER PUMP SCHEMATIC  
P-103 N.T.S.

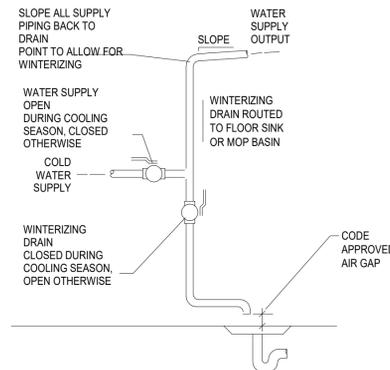

10 EVAPORATIVE COOLER WATER SUPPLY / DRAIN SCHEMATIC.  
P-103 N.T.S.

Countryman & Co.  
Architecture

108 SOUTH STANTON . THIRD FLOOR . EL PASO, TEXAS 79901 915.919.1827



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DRAWN BY: Author  
PROJECT NO: 2022-16  
ISSUED: 10/24/2022

REVISION SCHEDULE:

NO.	DATE	DESCRIPTION

THIS DRAWING IS INCOMPLETE AND NOT TO BE USED FOR CONSTRUCTION UNLESS IT IS STAMPED, SIGNED AND DATED.

TORNILLO INDEPENDENT SCHOOL DISTRICT CAFETERIA CONVERSION  
300 OIL MILL DR. | TORNILLO, TX 79853



SHEET TITLE:  
PLUMBING SCHEDULES & SCHEMATICS

Project Status

P-103

**SPECIFICATIONS**

- Notes:
- 4" FPT inlet/outlet with 4" plain end adapters, single inlet and triple outlet.
  - Unit weight - w/ cast iron covers: 376 lbs. (For wet weight add 2,310 lbs.)
  - Maximum operating temperature: 150° F continuous
  - Capacities - Liquid: 277 gal.; Grease: 1,895 lbs. (260 gal.) @100GPM Grease: 1,196 lbs. (164 gal.) @200GPM Solids: 69 gal.
  - This unit does not require flow control for 100 GPM applications. Built-in flow control is provided for 200 GPM applications. For series installations, only install flow control on the first unit in the series if necessary.
  - For gravity drainage applications only.
  - Do not use for pressure applications.
  - Cover placement allows full access to tank for proper maintenance.
  - Vent not required unless per local code.
  - Engineered inlet and outlet diffusers with inspection ports are removable to inspect / clean piping.
  - Integral air relief / Anti-siphon / Sampling access.
  - Adjustable cover adapters provide up to 4" of additional height.
  - Designed for below-grade, above-grade, indoor or outdoor installations.
  - Safety Star® access restrictor built into each cover adapter, prevents accidental entry to tanks (450 lb rating).

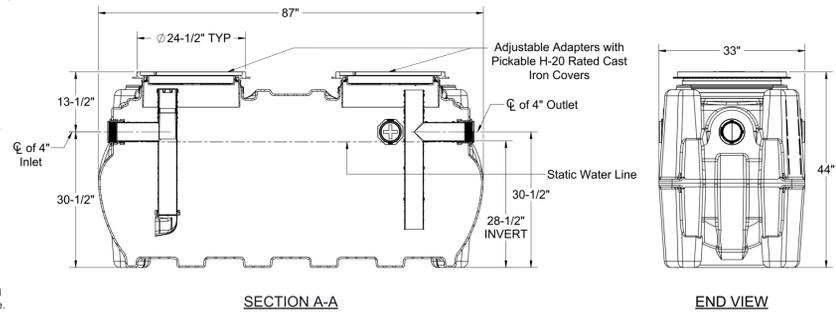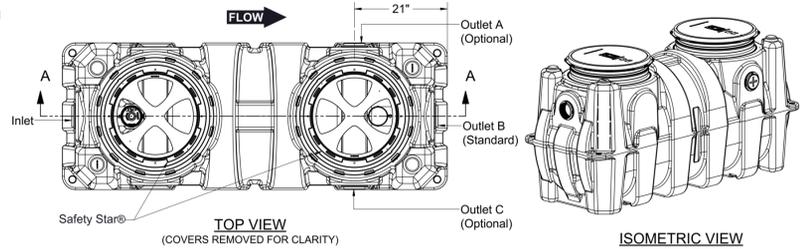

**ENGINEER SPECIFICATION GUIDE**  
Schier Great Basin™ grease interceptor model # GB-250 shall be lifetime guaranteed and made in USA of seamless, rotationally-molded polyethylene with minimum 3/8" uniform wall thickness. Interceptor shall be furnished for above or below-grade installation with adjustable cover adapters. Safety Star® access restrictor built into each cover adapter, built-in flow control (for 200 GPM only) and three outlet options. Interceptor shall be certified to ASME A112.14.3 (Type D for 100 GPM, type C for 200 GPM) and CSA B481.1. Interceptor flow rate shall be 100 GPM or 200 GPM. Interceptor grease capacity shall be 1,895 lbs. @ 100 GPM or 1,196 lbs. @ 200 GPM. Cover shall provide watertight seal and have minimum 16,000 lbs. load capacity.

**CERTIFIED PERFORMANCE**  
Great Basin™ hydromechanical grease interceptors are third party performance-tested and listed by IAPMO to ASME #A112.14.3 and CSA B481.1 grease interceptor standards and greatly exceed requirements for grease separation and storage. They are compliant to the Uniform Plumbing Code and the International Plumbing Code.

Type D certification does not require a flow control

**SPECIFICATION SHEET**

<b>MODEL NUMBER:</b> <b>GB-250</b>	<b>PART NUMBER:</b> 4055-007-02	<p>6455 Woodland Dr Shawnee, KS 66218 Tel: 913-951-3300 Fax: 913-951-3399 schierproducts.com</p>	
<b>DESCRIPTION:</b> GB-250 GREASE INTERCEPTOR 100 GPM / 200 GPM, 4" INLET/OUTLET, H-20 RATED CAST IRON COVERS			
<b>DWG BY:</b> C.SINCLAIR	<b>DATE:</b> 5/4/2022	<b>REV:</b> -	<b>ECO:</b> -

**GREASE INTERCEPTOR CALCULATIONS**

Reference No. 44570 Project Name: Tornillo HS Kitchen

**Step 1: Flow rate to grease interceptor**  
Fixture flow rate: (cu in / 231) = gal x 0.75 / 2 min = 2 min flow rate

NAME	TYPE	DIMENSIONS	QTY	CU IN	FLOW RATE
hand sink	Hand Sink	10" x 14" x 5"	2	1,400	2.26 GPM
ice machine	Ice Machine (with drain)	N/A	1	N/A	0.5 GPM
mop sink	Mop Basin	24" x 24" x 10"	1	5,760	9.35 GPM
pre-rinse	Pre-Rinse Sink One Bowl	20" x 20" x 5"	1	2,000	3.25 GPM
three comp sink	3 Compartment Sink	21" x 21" x 14" (3)	1	18,522	30 GPM
Trench drains	Floor Drain	N/A	4	N/A	N/A
Two Comp Sink	2 Compartment Sink	21" x 21" x 14" (2)	1	12,348	20 GPM
warming table	Warming Table (with drain)	N/A	1	N/A	0.5 GPM
<b>Total</b>					<b>65.86 GPM</b>

**Step 2: Grease Production**  
Servings per day x Grease production value x Days between pump-outs = Grease output  
Number of meals served per day: 400  
Grease production value: 0.0455 lbs per serving (Cafeteria - Full Serve: High / Flatware)  
Days between pump-outs: 90 days

400 x 0.0455 x 90 = 1638 lbs of FOG

SCHIER MODEL	Description: Polyethylene Grease Interceptor
<b>GB-250</b>	<b>Dimensions:</b> Length: 87", Width: 33", Height: 44" <b>Flow Rates/Grease Capacities:</b> 100 GPM / 1895.0 lbs <b>Liquid Capacity:</b> 277 gal

**1 GREASE INTERCEPTOR SUBMITTAL**  
P-104 N.T.S.



A. O. Smith  
Phone: 1.866.362.9898  
www.hotwater.com

**Pro-Size Selection Report**

October 22, 2022

**Project Information**

Project #: Prepared for:  
Project Name: Prepared by:  
Location:  
Engineer:  
Contractor:

**Selected Product**

**BTH-400 Mxi**  
**Cyclone® Mxi Modulating**

# Heaters: 1 Heater Recovery: 575 USGPH @ 80 °F Rise  
Model Number: BTH-400 Mxi 1st Hour Delivery: 658 USGPH  
Heater Storage (ea): 119 USG 3 Hour Average: 603 USGPH  
Input (ea): 399,900 Btu/hr Est. Storage Recovery: 12 min  
New External Tanks: 0 % Of Demand: 110%  
Tank Capacity (ea): 0 USG  
Total Usable Storage: 83 USG



Model Number	Hi Cube Trailer Load Factor	Gallon Capacity	Recovery Capacity GPH 100 Degree Rise	Input BTU/HR	Height	Diameter	Approx. Shipping Weight (lbs.)
BTH-400 Mxi	3.33	119	460	399,900	75.75	33.12	825

- Standard and Low profile concentric vent available
- Vents with PVC, CPVC polypropylene and AL-29-4C Stainless steel
- Venting distances of up to 120' on all models
- Meets or exceeds the thermal efficiency and for standby loss requirements of the U.S. Department of Energy and current edition of ASHRAE/IESNA 90.1
- Meets NSF requirements (no leg kit needed)
- Up to 98% Thermal Efficiency
- Down-Fired Low-NOx Powered-Burner Design
- Fully Submerged, Spiral-Shaped Condensing Heat Exchanger
- Complies with SCAQMD Rule 1146.2
- Sidewall and Vertical power vent and direct Vent Options
- Space-Saving Design, with Zero Clearance to Combustibles

**Application Loads**

**Summary**  
Peak Demand: 600 USGPH Temperature Rise: 80 °F

**Application Settings**

Type: Food Service / Restaurant  
Building Use: Not Specified Cold Water Temp: 60 °F  
Peak Demand Period: 1.00 Hours Stored Water Temp: 140 °F  
Equipment: Water Heaters Only (no external storage) Approx. Storage: 25%  
Fuel Type: Natural Gas # Storage Tanks: Not Specified  
Location: Indoor Existing Storage: None

The A. O. Smith Pro-Size sizing program is a tool that can be used to estimate water heater requirements for many common applications. Pro-Size is intended to assist in selecting water heaters or boilers that best meet the specific job requirements. It is the sole responsibility of the system designer to select the correct products needed for the specific application. A. O. Smith reserves the right to make changes to Pro-Size without notice.

**2 WATER HEATER SUBMITTAL**  
P-104 N.T.S.

LoNOx: Required  
UltraLowNOx: Not Required  
ASME: Not Required  
# Heaters: Not Specified  
Altitude: Less than 2000 ft

**Load Data**

Meals Served: 400 Per Day  
Vegetable Sinks: 1  
Single Pot Sink: 0  
Double Pot Sink: 1  
Triple Pot Sink: 1  
Pre-scraper (open type): 1  
Pre-flush (hand operated): 0  
Pre-flush (closed type): 0  
Recirculating Pre-flush: 0  
Bar Sink: 0  
Lavatories: 3  
Mop/Step Sink: 2  
Dishwasher - Model 1: 1 @ 100 USGPH (140 °F)  
Dishwasher - Model 2: 0 @ 0 USGPH (140 °F)  
Pot Washer - Model 1: 0 @ 0 USGPH (180 °F)  
Pot Washer - Model 2: 0 @ 0 USGPH (180 °F)  
Additional Load: 0 USGPH  
Design Oversize: 0%

The A. O. Smith Pro-Size sizing program is a tool that can be used to estimate water heater requirements for many common applications. Pro-Size is intended to assist in selecting water heaters or boilers that best meet the specific job requirements. It is the sole responsibility of the system designer to select the correct products needed for the specific application. A. O. Smith reserves the right to make changes to Pro-Size without notice.

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**REVISION SCHEDULE:**

NO.	DATE	DESCRIPTION

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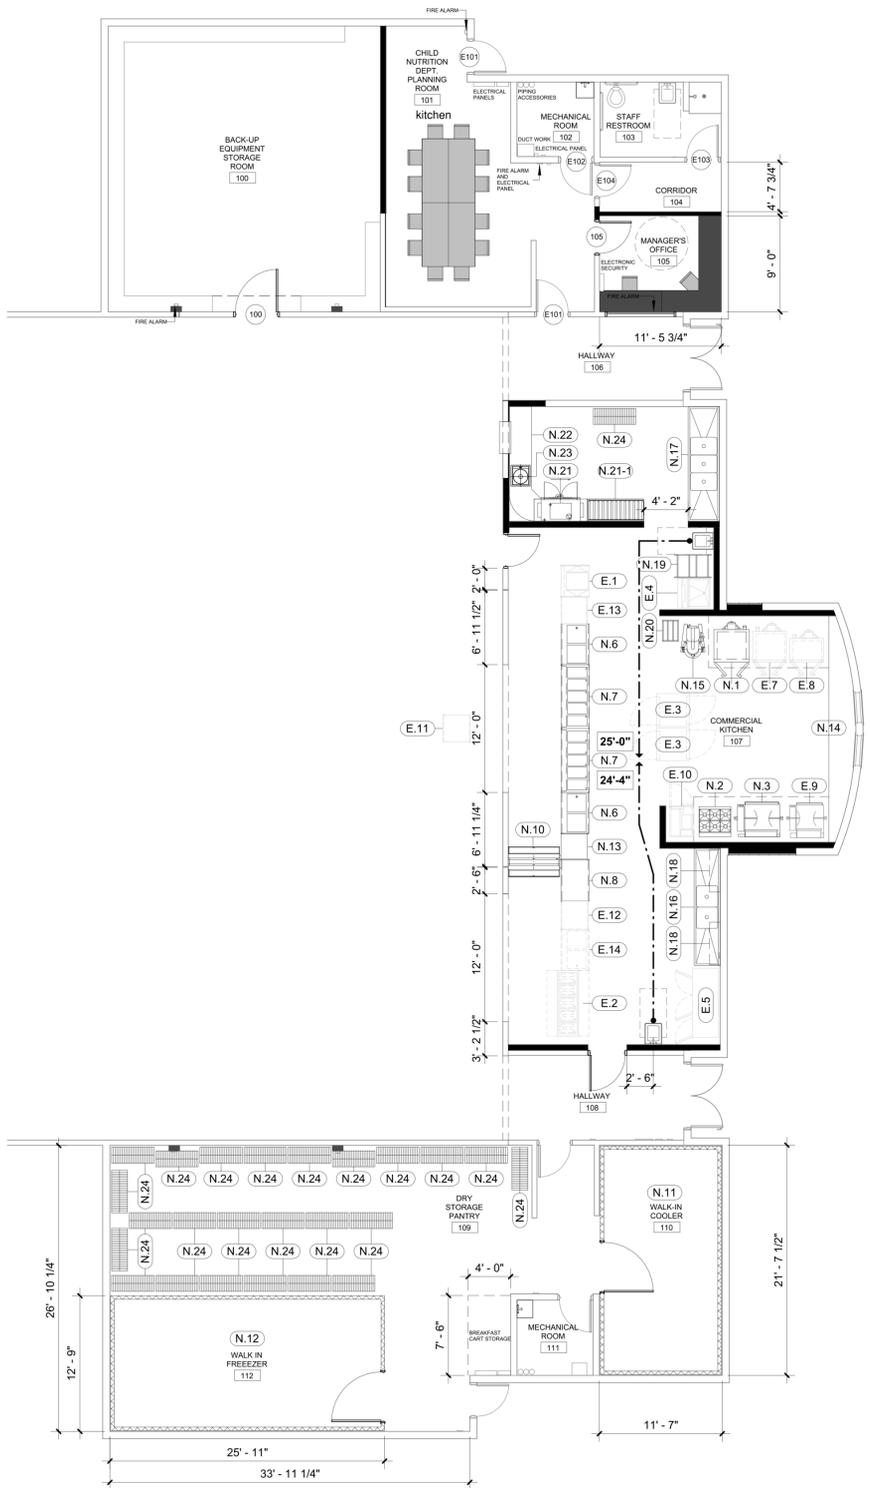
**TORNILLO INDEPENDENT SCHOOL DISTRICT CAFETERIA CONVERSION**  
300 OIL MILL DR. | TORNILLO, TX 79853

SHEET TITLE:

**PLUMBING SCHEDULES & SCHEMATICS**

Project Status

**P-104**



01 KITCHEN EQUIPMENT PLAN  
1/8" = 1'-0"



NEW EQUIPMENT SCHEDULE

NO.	QTY.	SYMBOL	IMAGE	SIZE	DESCRIPTION	MANUFACTURER   MODEL NO.	PROVIDER   INSTALLER
<b>ELECTRIFIED AND   OR PLUMBED EQUIPMENT</b>							
N.1	1	[Symbol]	[Image]	70" H * 40" W * 46 1/4" D	GAS CONVECTION OVEN	VULCAN   VC66GD	OWNER   GC
N.2	1	[Symbol]	[Image]	58" H * 36" W * 34" D	STANDARD OVEN 6 BURNERS PROPANE	VULVAN   36S-6BP	OWNER   GC
N.3	1	[Symbol]	[Image]	43 1/2" H * 48 W * 39 1/4" D	GAS TILTING SKILLET BRAISING PAN	GROEN   BPM-40GA	OWNER   GC
N.4		[Symbol]	[Image]		FLOOR TROUGH REFER TO ENGINEER		GC   GC
N.5		[Symbol]	[Image]		EXHAUST HOOD REFER TO ENGINEER		GC   GC
N.6L	2	[Symbol]	[Image]	36" H * 32" W * 32" D	SERVING COUNTER, COLD FOOD	DUKE   TCM-32PG-N7	OWNER   GC
N.6R		[Symbol]	[Image]				
N.7L	2	[Symbol]	[Image]	36" H * 72" W * 32" D	SERVING COUNTER, HOT FOOD	DUKE   TEHF-74PG	OWNER   GC
N.7R		[Symbol]	[Image]				
N.8	1	[Symbol]	[Image]	36" H * 46" W * 32" D	SERVING COUNTER, UTILITY	DUKE   TST-46PG	OWNER   GC
N.9	NOT USED	[Symbol]	[Image]	36" H * 30" W * 32" D	CASH REGISTER STAND	DUKE   TCS-30PG	OWNER   GC
N.10	1	[Symbol]	[Image]	47 3/4" H * 58" W * 34" D	MILK COOLER	BEVERAGE AIR   STF58HC-1-W-02	OWNER   GC
N.11	1	[Symbol]	[Image]		WALK-IN COOLER		GC   GC
N.12	1	[Symbol]	[Image]		WALK-IN FREEZER		GC   GC
N.13	1	[Symbol]	[Image]	30" W * 30" D	TABLE		OWNER   GC
N.14	1	[Symbol]	[Image]		CUSTOM STAINLESS STEEL TABLE		GC   GC
N.15	1	[Symbol]	[Image]	26 1/2" W * 26 9/16" D * 47 1/8" H	40 QUARTS MIXER	VOLLRATH   MIX1040	OWNER   GC
N.16	1	[Symbol]	[Image]		CUSTOM 2 COMPARTMENT SINK WITH STAINLESS STEEL DRAIN BOARDS	CUSTOM EQUIPMENT	GC   GC
N.17	1	[Symbol]	[Image]		CUSTOM 3 COMPARTMENT SINK	CUSTOM EQUIPMENT	GC   GC
N.18	2	[Symbol]	[Image]	12" D * 48" L	WALL MOUNTED SHELF	ADVANCE TABCO   WS-12-48	OWNER   GC
N.19	2	[Symbol]	[Image]	20 1/4" W * 26 1/2" L * 69" H	20 PAN ALUMINUM PAN RACK WA CASTERS KTI	KLINGER'S TRADING, INC.   PANRACK20	OWNER   OWNER
N.20	1	[Symbol]	[Image]	24" W * 18" D * 8" H	ALUMINUM DUNNAGE RACK	GLOBAL INDUSTRIAL   799142	OWNER   OWNER
N.21	1	[Symbol]	[Image]		RACK CONVEYOR DISHWASHING MACHINE (R-L)	CHAMPION   44 DR	GC   GC
N.21-1		[Symbol]	[Image]		ROLLER CONVEYOR TABLE	CHAMPION   RCT64 TABLE	
N.22	1	[Symbol]	[Image]		CUSTOM STAINLESS STEEL TABLE	CUSTOM EQUIPMENT	GC   GC
N.23	1	[Symbol]	[Image]	24 1/2" W * 26 13/16" L	SCRAP COLLECTOR	SALVAJOR   S914	OWNER   GC
N.24	25	[Symbol]	[Image]	18" D * 48" L	EPOXY SHELF WITH LOCKING WHEELS		OWNER   OWNER

EXISTING EQUIPMENT SCHEDULE

NO.	QTY.	SYMBOL	IMAGE	SIZE	DESCRIPTION	MANUFACTURER   MODEL NO.	PROVIDER   INSTALLER
<b>ELECTRIFIED AND   OR PLUMBED EQUIPMENT</b>							
E.1	1	[Symbol]	[Image]	36 1/4" W * 33" D	REFRIGERATOR SELF-SERVICE CASE ( MILK COOLER)	OASIS   CO34R	EXISTING   GC
E.2	1	[Symbol]	[Image]	74" L * 48" D	5 BIM WARMER	DUKE   EP305-25	EXISTING   GC
E.3	2	[Symbol]	[Image]	35" W * 36 7/8" D	ROLL-THRU SOLID DOUBLE DOORS HEATED CABINET	TRUE   TG1HRT-1S-1S	EXISTING   GC
E.4	1	[Symbol]	[Image]	33" W * 37" D	ICE STORAGE BIN	SCOTSMAN   B530P	EXISTING   GC
E.5	1	[Symbol]	[Image]	78 1/8" L * 29 1/2" D	3 SOLID DOOR REFRIGERATOR	TRUE   T-72	EXISTING   GC
E.6	NOT USED	[Symbol]	[Image]				EXISTING
E.7	1	[Symbol]	[Image]	38" W * 44 7/8" D	GAS CONVECTION OVEN	IMPERIAL	EXISTING   GC
E.8	1	[Symbol]	[Image]	38 1/4" W * 36 7/8" D	GAS CONVECTION OVEN	BLODGETT   DFG-200	EXISTING   GC
E.9	1	[Symbol]	[Image]	38 1/2" W * 39 1/4" D	BRAISING PAN	GROEN ECLIPSE   M-30G	EXISTING   GC
E.10	1	[Symbol]	[Image]	27 1/2" W * 34 7/8" D	HEATED HOLDING CABINET	MCCALL   4020-HP	EXISTING   GC
E.11	1	[Symbol]	[Image]	30" W * 31" D	REGISTER STAND		
E.12	1	[Symbol]	[Image]	32" W * 31" D	TABLE		
E.13	1	[Symbol]	[Image]	30" W * 30" D	TABLE		
E.14	1	[Symbol]	[Image]	36" H * 32" W * 32" D	SERVING COUNTER, COLD FOOD	DUKE   TCM-32PG-N7	EXISTING   GC

**LEGEND**

- [Symbol] EQUIPMENT REFER TO KITCHEN EQUIPMENT SCHEDULE
- [Symbol] FURNITURE OWNER PROVIDED | OWNER INSTALLED
- [Symbol] MILLWORK CONTRACTOR PROVIDED | CONTRACTOR INSTALLED

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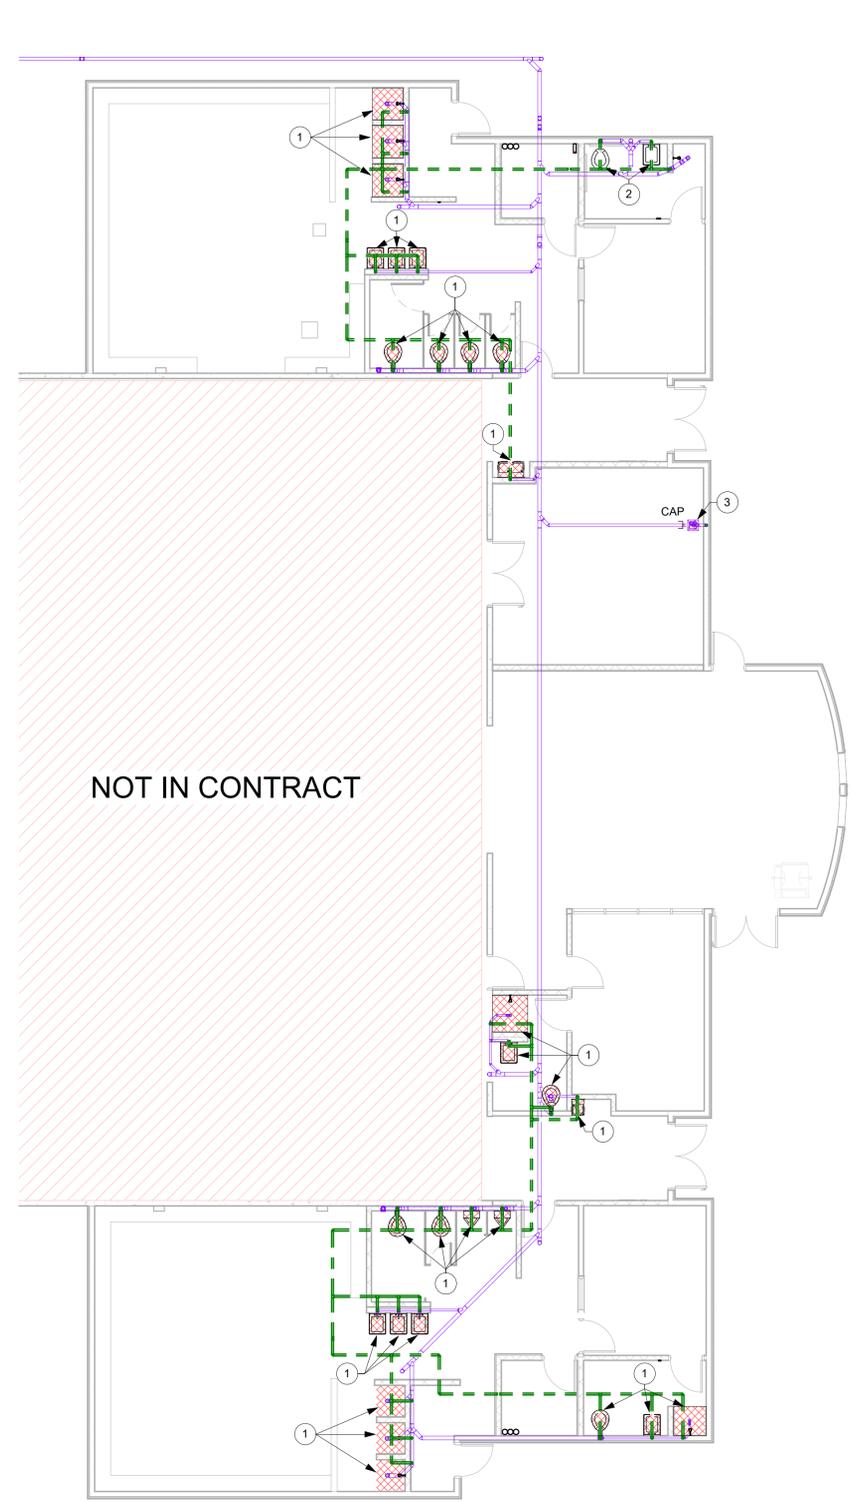
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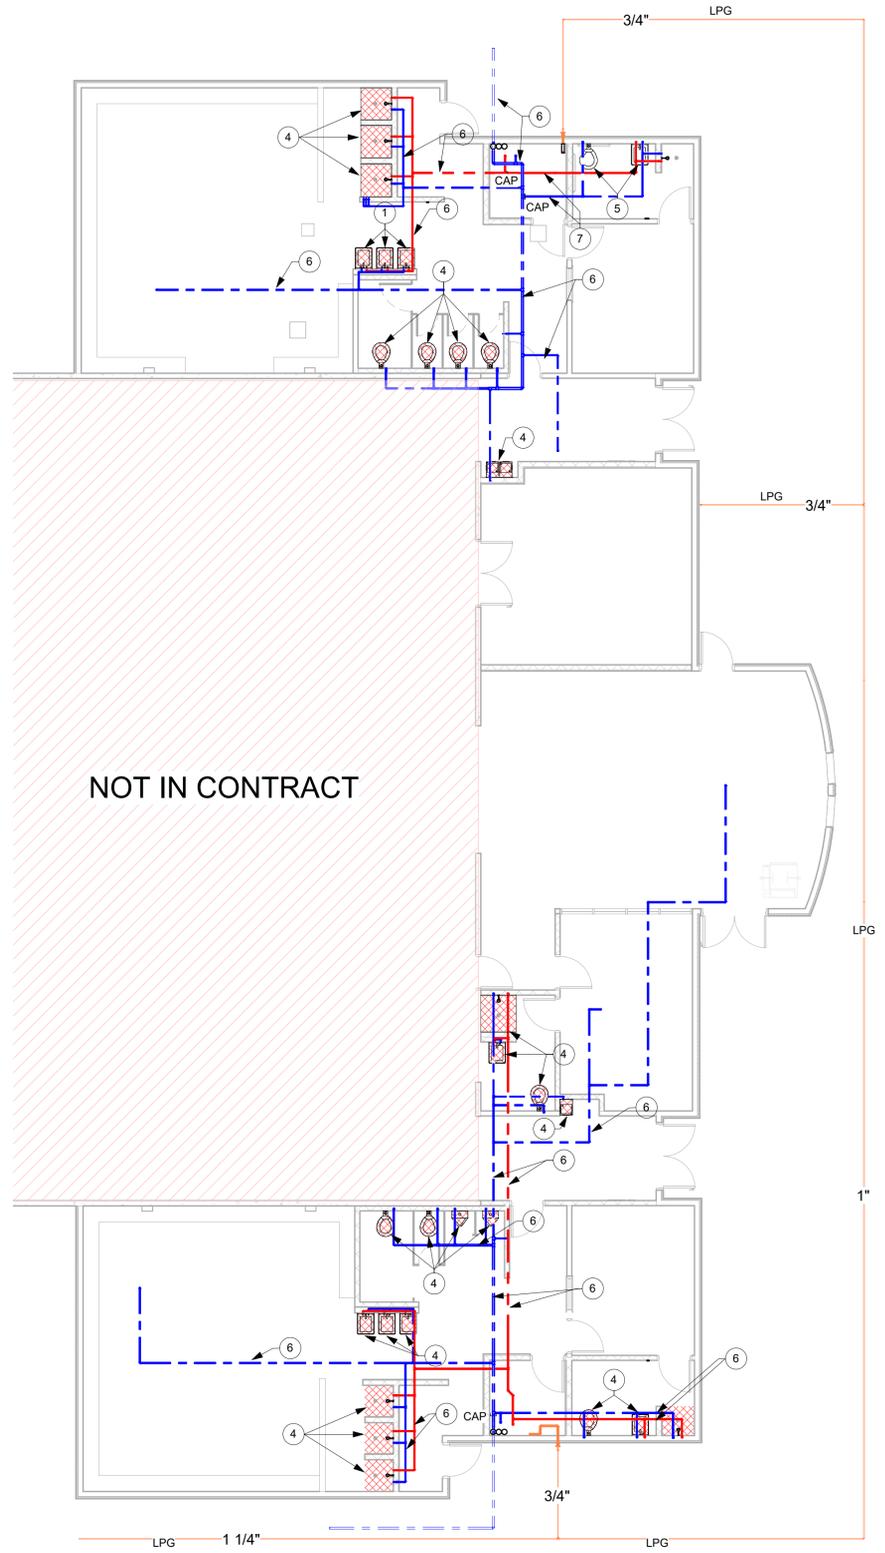
SHEET TITLE:  
**PLUMBING SCHEDULES & SCHEMATICS**

Project Status

P-105



1 1ST LEVEL WASTE & VENT PLUMBING DEMOLITION PLAN  
P-200 1/8" = 1'-0"



2 HOT & COLD WATER PLUMBING DEMOLITION PLAN  
P-200 1/8" = 1'-0"

**KEYED NOTES**

1. HOT AND COLD WATER, SEWER AND VENT LINES ASSOCIATED WITH PLUMBING FIXTURE SHALL BE REMOVED AND CAPPED BACK TO MAIN. PATCH WALL AS REQUIRED TO MATCH EXISTING.
2. EXISTING FIXTURE UNIT SHALL REMAIN UNDISTURBED.
3. EXISTING FLOOR SINK SHALL BE REMOVED FROM SITE. NEW FLOOR SINK SHALL BE INSTALLED IN THE SAME PLACE. ASSOCIATED SEWER LINE SHALL BE CAPPED BACK TO ALLOW SPACE FOR NEW SEWER LINE.
4. PLUMBING FIXTURES SHALL BE REMOVED FROM SITE. HOT AND COLD WATER, SEWER AND VENT LINES ASSOCIATED WITH PLUMBING FIXTURE SHALL BE CAPPED BACK TO WALL AND BE ABANDONED IN PLACE.
5. EXISTING FIXTURE UNIT SHALL REMAIN UNDISTURBED.
6. EXISTING DOMESTIC WATER LINE SHALL BE ABANDONED IN PLACE.
7. PIPE SEGMENT SHALL BE REMOVED AND CAPPED BACK TO MAIN. REMAINDER OF PIPING SERVING RESTROOM SHALL REMAIN AND SERVE AS POINT OF CONNECTION FOR NEW DOMESTIC WATER PIPING.

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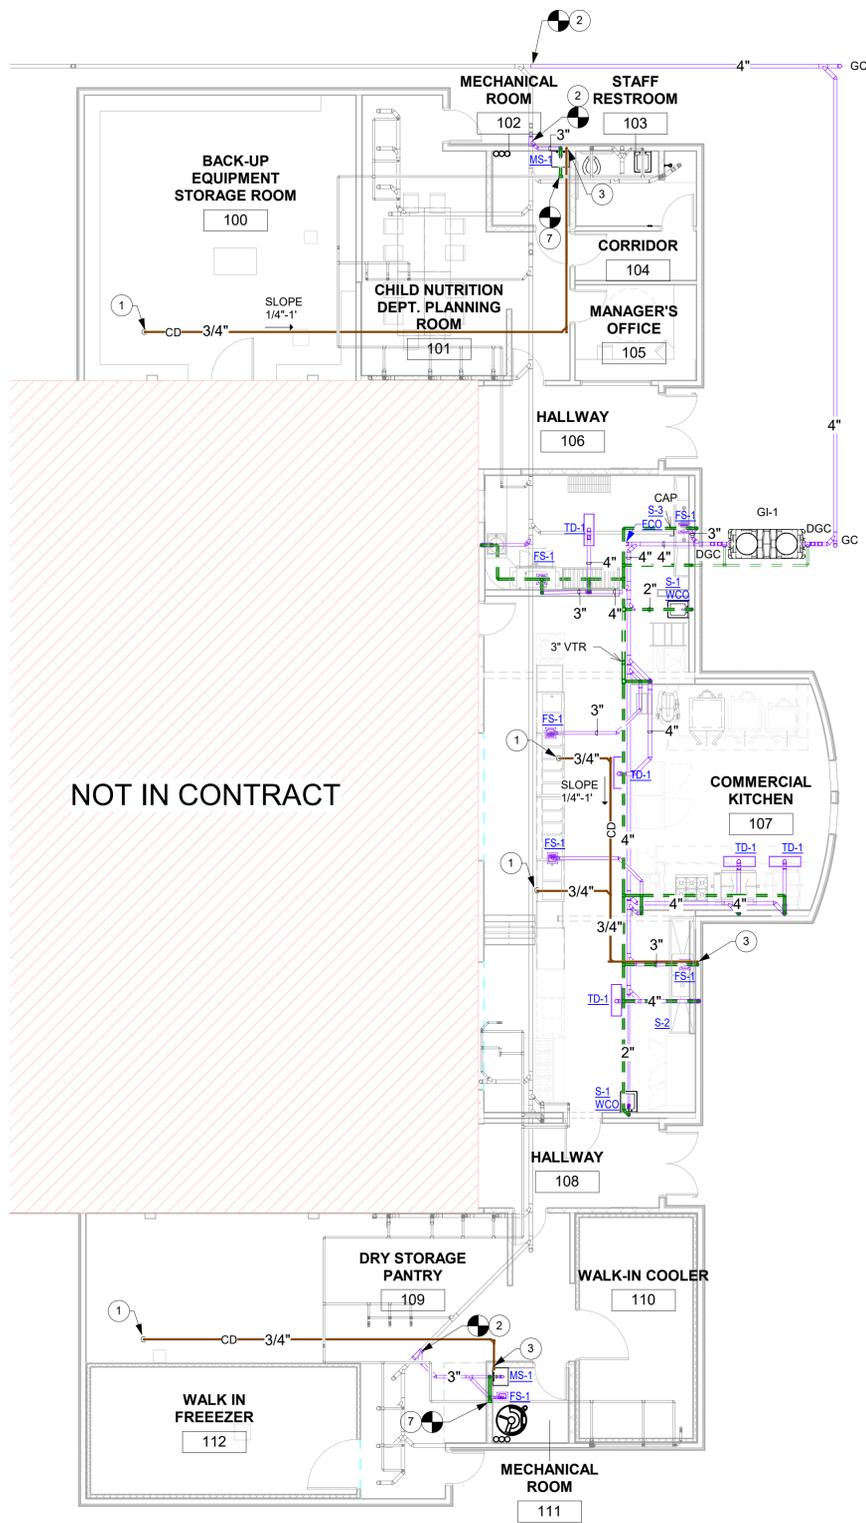
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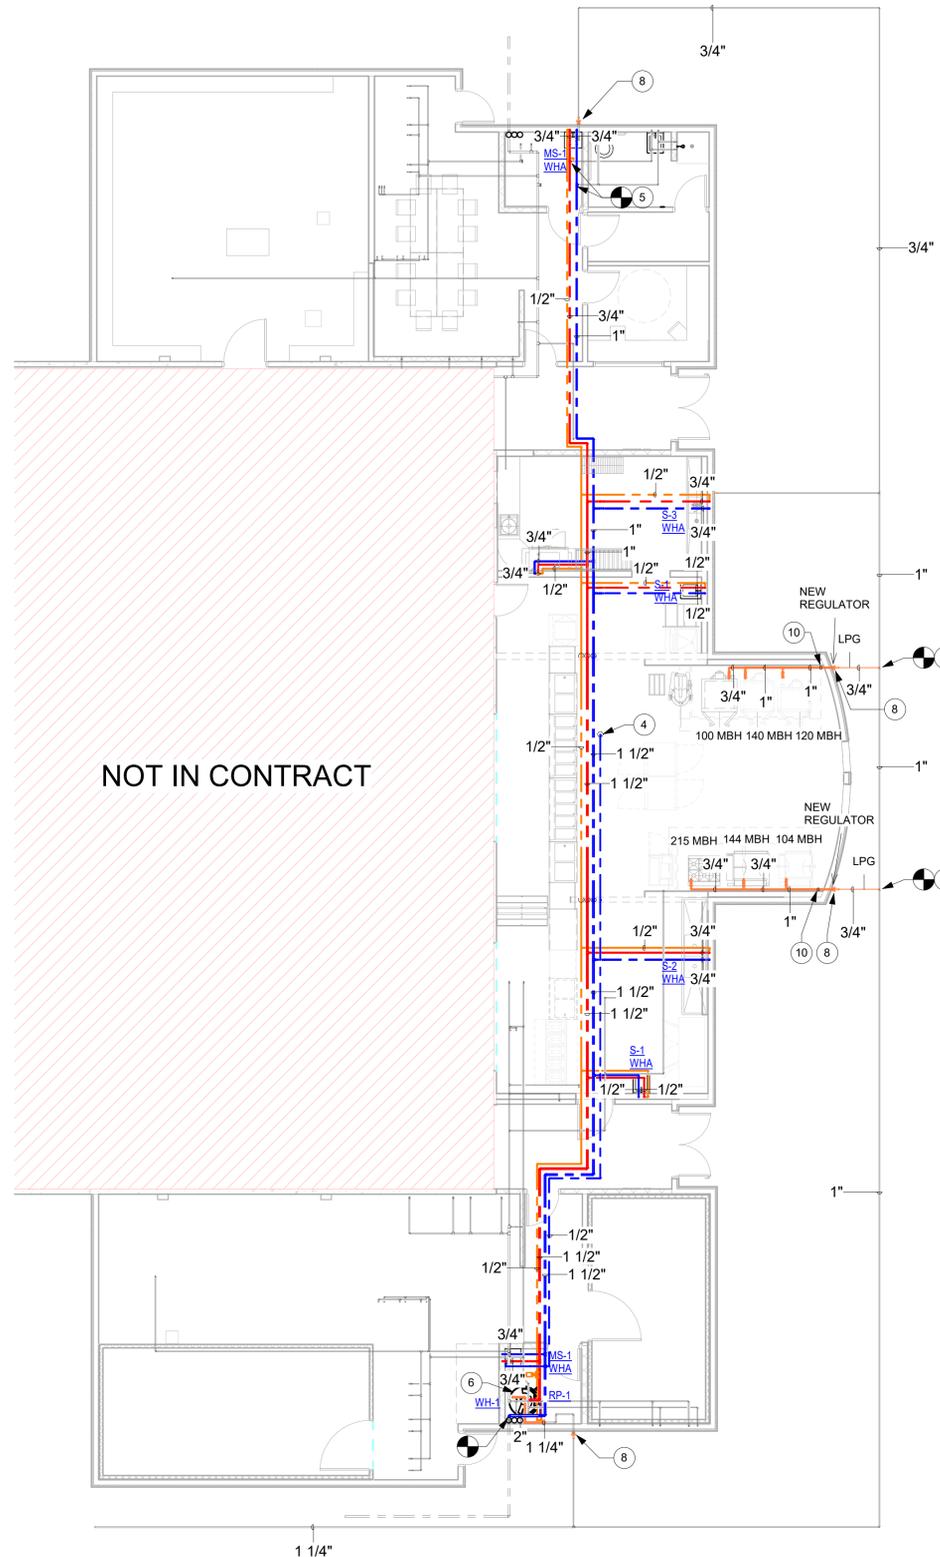
SHEET TITLE:  
**PLUMBING DEMOLITION PLAN**

Project Status

**P-200**



1 1ST LEVEL WASTE & VENT PLUMBING IMPROVEMENT PLAN  
P-300 1/8" = 1'-0"



2 1ST LEVEL HOT & COLD WATER PLUMBING IMPROVEMENT PLAN  
P-300 1/8" = 1'-0"

ALL NEW AND EXISTING GAS PIPING SHALL BE TESTED PER 2015 IFGC.

KEYED NOTES

- 3/4" CONDENSATE DRAIN LINE DOWN FROM ROOF TOP UNIT. INSULATE ALL PIPING AS SPECIFIED.
- CONNECT NEW SEWER LINE TO EXISTING SEWER MAIN.
- EXTEND CONDENSATE DRAIN LINE OVER MOP SINK. TERMINATE 1'.
- DOMESTIC WATER PIPE GOES UP TO MAKE UP AIR UNIT EVAPORATIVE MODULE. REFER TO EVAPORATIVE COOLER WATER SUPPLY/DRAIN SCHEMATIC.
- CONNECT NEW WATER PIPING TO EXISTING WATER PIPING SERVING RESTROOM PLUMBING FIXTURES.
- EXTEND (2) 4" SCH 40 PVC PIPES FROM NEW WATER HEATER AND CONNECT TO CONCENTRIC AO SMITH VENT KIT. REFER TO SCHEMATIC PLANS FOR MORE INFORMATION. ALIGN VENT THROUGH EXISTING ROOF PENETRATION.
- CONNECT VENT SERVING NEW FIXTURES TO EXISTING VENT PIPING.
- PROVIDE AND INSTALL NEW LPG REGULAR CAPABLE OF HANDLING LISTED PEAK LOAD DEMAND AT A DISCHARGE PRESSURE OF 14" W.C.
- CONNECT NEW P.E. GAS LINE TO EXISTING GAS MAIN.
- CONTRACTOR SHALL INSTALL NEW GAS SOLENOID VALVE. INTERLOCK WITH ANSUL/KITCHEN VENTILATION SYSTEM.

GAS LOAD DEMAND CALCULATION

MARK	DESCRIPTION	MBH
N-1	CONVECTION OVEN	100
N-2	RANGE / OVEN	215
N-3	TILTING SKILLET	144
E-7	DOUBLE OVEN	160
E-8	DOUBLE OVEN	120
E-9	TILTING SKILLET	104
RTU-OFFICE	PACKAGED ROOF TOP	67.2
RTU-PSNTRY	PACKAGED ROOF TOP	67.2
RTU-KITCHEN	PACKAGED ROOF TOP	100.8
WH-1	WATER HEATER	399

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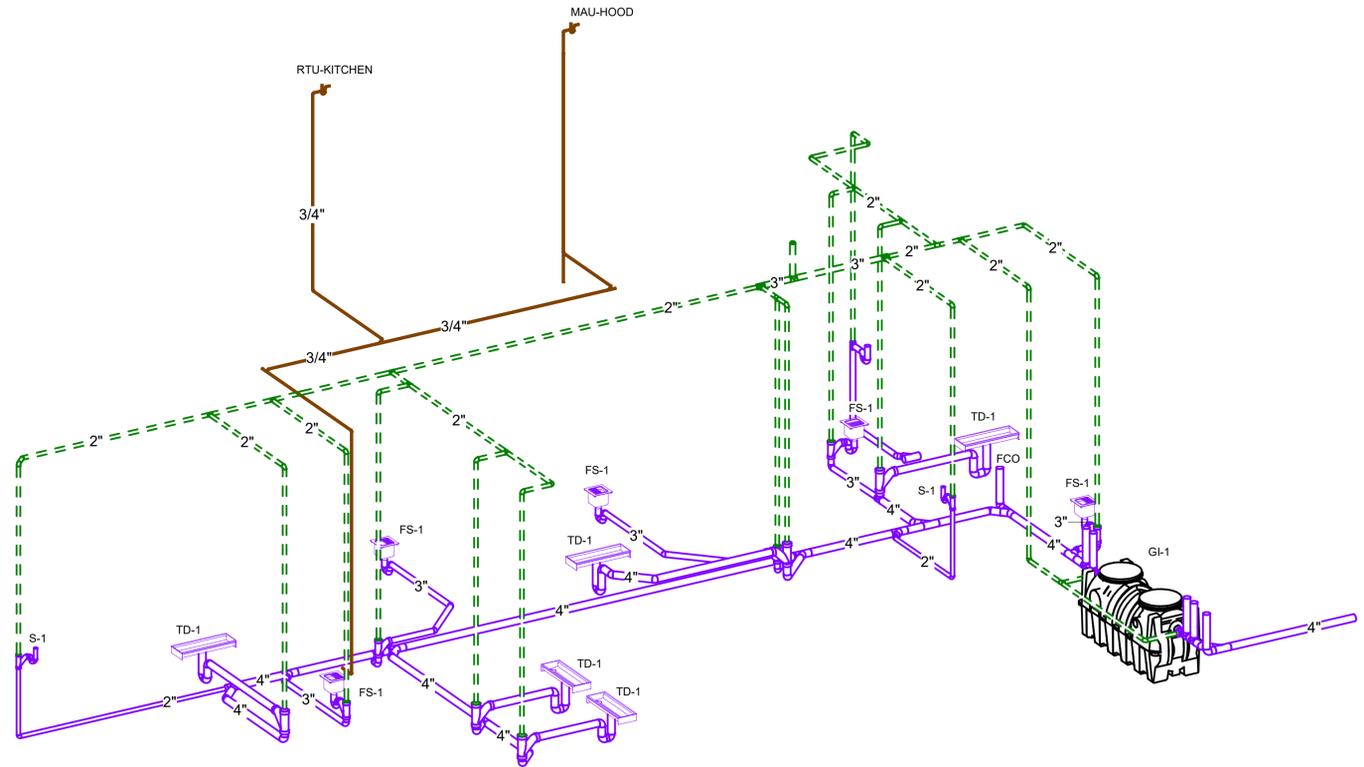
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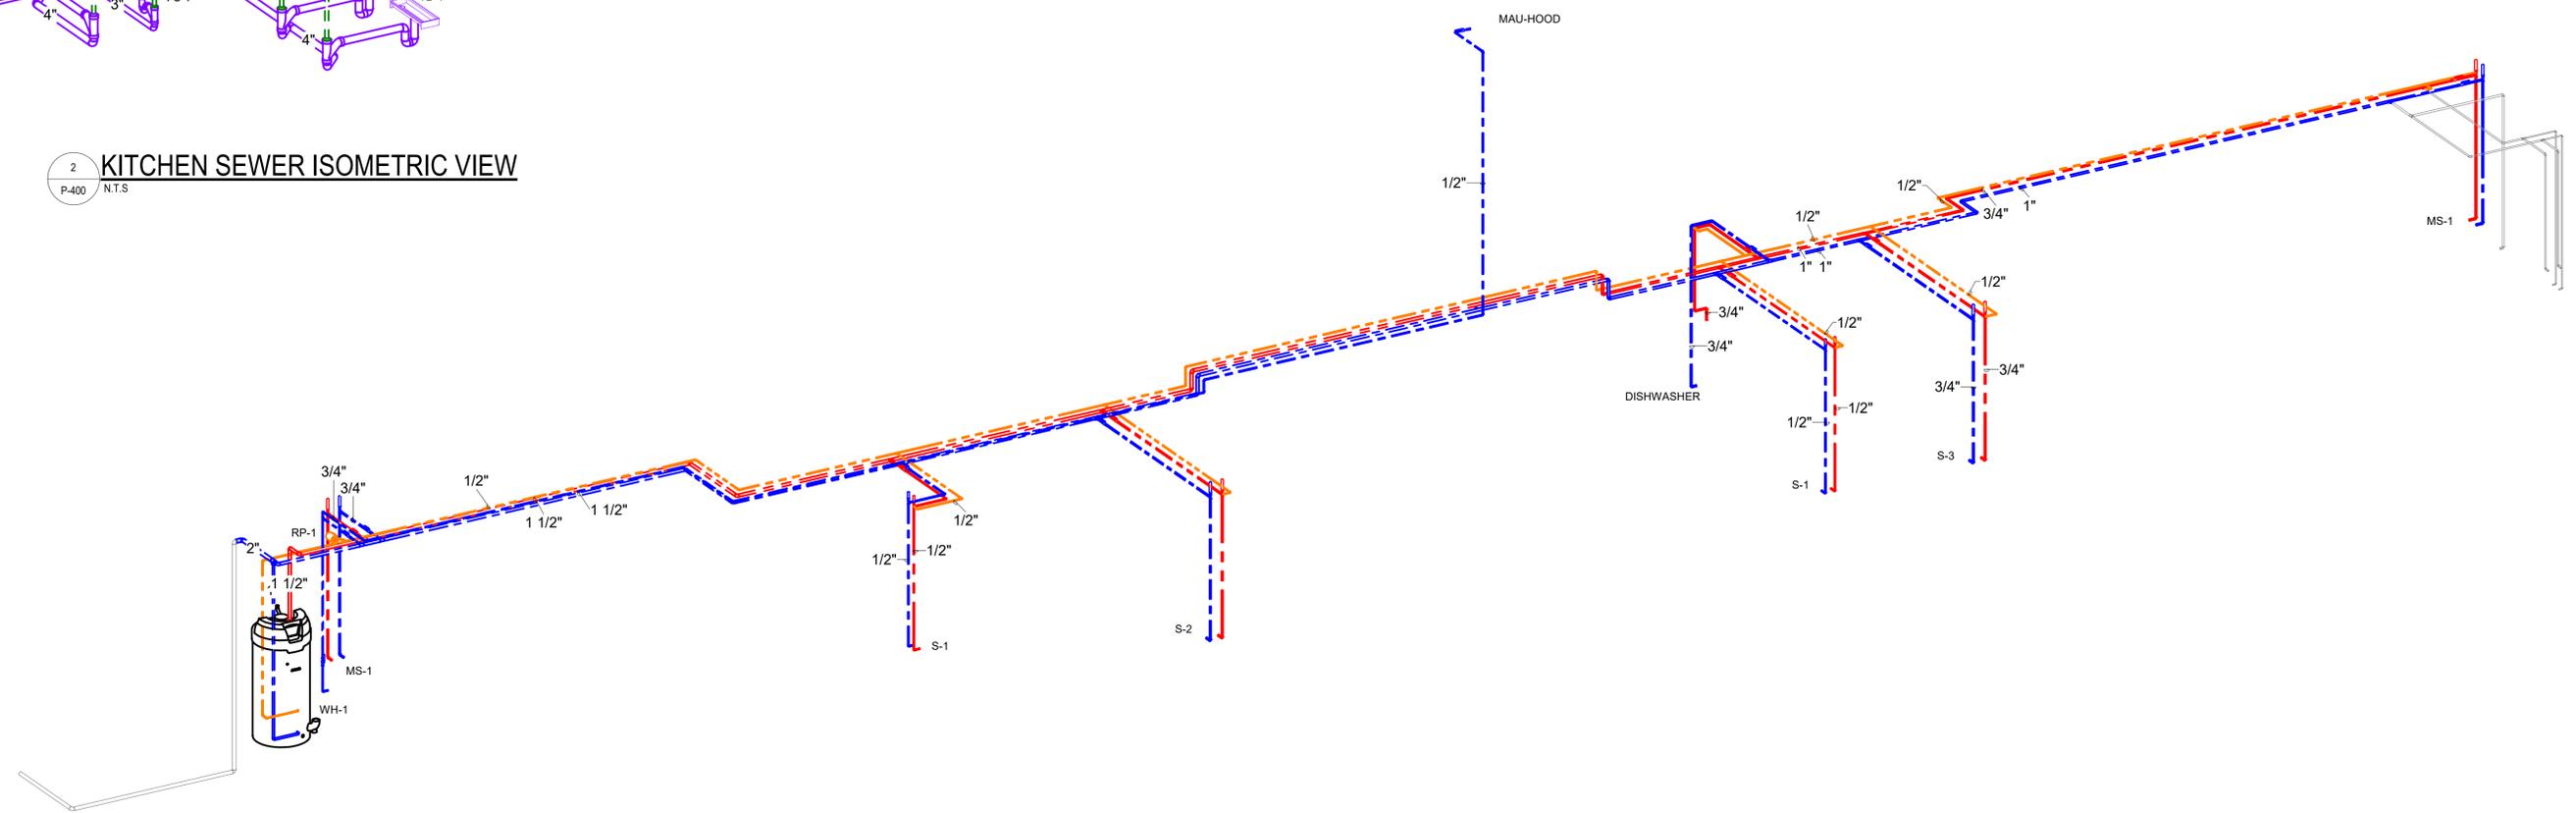
SHEET TITLE:  
PLUMBING IMPROVEMENT PLAN

Project Status

P-300



2 KITCHEN SEWER ISOMETRIC VIEW  
P-400 N.T.S.



1 KITCHEN HOT & COLD WATER ISOMETRIC VIEW  
P-400 N.T.S.

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Project Status

**P-400**

SHEET TITLE:  
**PLUMBING ISOMETRIC VIEWS**